

WORKS AND SERVICES DEPARTMENT GOVERNMENT OF SINDH



Asian Development Bank

LOAN NO. 4279-PAK (COL): EMERGENCY FLOOD ASSISTANCE PROJECT (EFAP)

PACKAGE No. 13

SB-2

IMPROVEMENT / REHABILITATION OF ROAD FROM 60th MILE TO CONNECT 3 CHAK VIA 68th MILE AND CHAUDHARY NAZEER ROAD

(Length: 31.905 kms, Width: 5.5 m)




Engineering Consultant Int'l. (Pvt.) Ltd.

A.A.ASSOCAITES

JULY - 2023

TENDER DRAWING

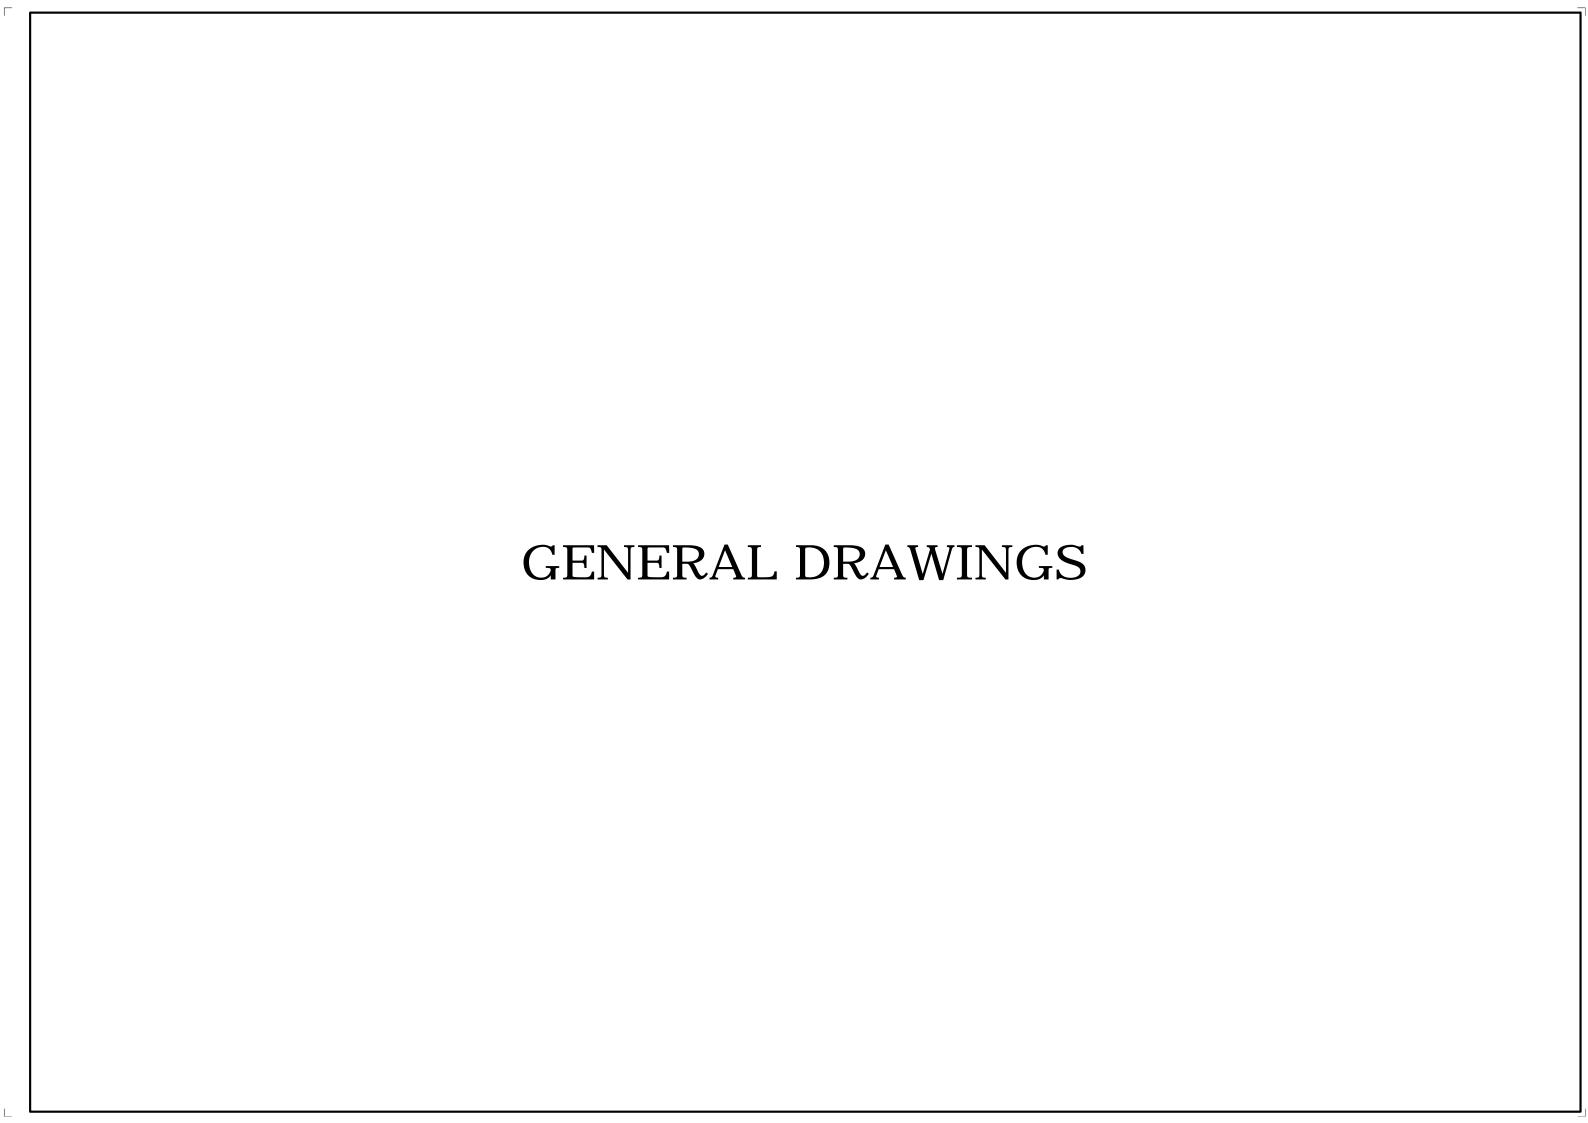

LIST OF DRAWINGS

GENERAL DRAWINGS

DWG. NO.	TITLE
SB-2 GEN-01	LIST OF DRAWINGS
SB-2 GEN-02	LOCATION PLAN
SB-2 GEN-03	GENERAL NOTES
SB-2 GEN-04	SYMBOLS & ABBRIVIATIONS
SB-2 GEN-05	TYPICAL ROAD SIGNS (SHEET 1 OF 3)
SB-2 GEN-05A	TYPICAL ROAD SIGNS (SHEET 2 OF 3)
SB-2 GEN-05B	TYPICAL ROAD SIGNS (SHEET 3 OF 3)
SB-2 GEN-06	TYPICAL SIGN PLACING & FOUNDATION DETAILS
SB-2 GEN-07	TYPICAL PAVEMENT MARKING (SHEET 1 OF 3)
SB-2 GEN-07A	TYPICAL PAVEMENT MARKING (SHEET 2 OF 3)
SB-2 GEN-07B	DETAIL OF PAVEMENT MARKING (SHEET 3 OF 3)
SB-2 GEN-08	DETAIL OF MERGING/DIVERGING AND ROAD STUDS
SB-2	TYPICAL CROSS SECTION
	RD. 0+000 TO END (REHABILITATION 5.5)
PW-SB-2	PROTECTION WORK SCHEDULE

GENERAL DRAWINGS

DWG. NO.	TITLE	
SB-2 PP-01	PLAN AND PROFILE (RD. 0+000 TO RD. 1	1+000)
SB-2 PP-02	PLAN AND PROFILE (RD. 1+000 TO RD. 2	2+000)
SB-2 PP-03	PLAN AND PROFILE (RD. 2+000 TO RD. 3	3+000)
SB-2 PP-04	PLAN AND PROFILE (RD. 3+000 TO RD. 4	1+000)
SB-2 PP-05	PLAN AND PROFILE (RD. 4+000 TO RD. 5	5+000)
SB-2 PP-06	PLAN AND PROFILE (RD. 5+000 TO RD. 6	3+000)
SB-2 PP-07	PLAN AND PROFILE (RD. 6+000 TO RD. 7	7+000)
SB-2 PP-08	PLAN AND PROFILE (RD. 7+000 TO RD. 8	3+000)
SB-2 PP-09	PLAN AND PROFILE (RD. 8+000 TO RD. 9	9+000)
SB-2 PP-10	PLAN AND PROFILE (RD. 9+000 TO RD. 1	10+000

GENERAL DRAWINGS

DWG. NO.	<u>TITLI</u>	$\mathbf{\underline{c}}$						
SB-2 PP-11	PLAN	AND	PROFILE	(RD.	10+000	ТО	RD.	11+000)
SB-2 PP-12	PLAN	AND	PROFILE	(RD.	11+000	ТО	RD.	12+000)
SB-2 PP-13	PLAN	AND	PROFILE	(RD.	12+000	ТО	RD.	13+000)
SB-2 PP-14	PLAN	AND	PROFILE	(RD.	13+000	ТО	RD.	14+000)
SB-2 PP-15	PLAN	AND	PROFILE	(RD.	14+000	ТО	RD.	15+000)
SB-2 PP-16	PLAN	AND	PROFILE	(RD.	15+000	ТО	RD.	16+000)
SB-2 PP-17	PLAN	AND	PROFILE	(RD.	16+000	ТО	RD.	17+000)
SB-2 PP-18	PLAN	AND	PROFILE	(RD.	17+000	ТО	RD.	18+000)
SB-2 PP-19	PLAN	AND	PROFILE	(RD.	18+000	ТО	RD.	19+000)
SB-2 PP-20	PLAN	AND	PROFILE	(RD.	19+000	ТО	RD.	20+000)
SB-2 PP-21	PLAN	AND	PROFILE	(RD.	20+000	ТО	RD.	21+000)
SB-2 PP-22	PLAN	AND	PROFILE	(RD.	21+000	ТО	RD.	22+000)
SB-2 PP-23	PLAN	AND	PROFILE	(RD.	22+000	TO	RD.	23+000)
SB-2 PP-24	PLAN	AND	PROFILE	(RD.	23+000	ТО	RD.	24+000)
SB-2 PP-25	PLAN	AND	PROFILE	(RD.	24+000	TO	RD.	25+000)
SB-2 PP-26	PLAN	AND	PROFILE	(RD.	25+000	TO	RD.	26+000)
SB-2 PP-27	PLAN	AND	PROFILE	(RD.	26+000	ТО	RD.	27+000)
SB-2 PP-28	PLAN	AND	PROFILE	(RD.	27+000	TO	RD.	28+000)
SB-2 PP-29	PLAN	AND	PROFILE	(RD.	28+000	TO	RD.	29+000)
SB-2 PP-30	PLAN	AND	PROFILE	(RD.	29+000	TO	RD.	30+000)
SB-2 PP-31	PLAN	AND	PROFILE	(RD.	30+000	ТО	RD.	31+000)
SB-2 PP-32	PLAN	AND	PROFILE	(RD.	31+000	ТО	RD.	31+817.037)

JECT:-
LOAN N


WORKS AND SERVICES DEPARTMENT GOVERNMENT OF SINDH

LOAN NO. 4279 (COL): EMERGENCY FLOOD ASSISTANT PROJECT (EFAP)





PROJECT ROA	D:- SB - 2	E
	rovement / Rehabilitation of road from 60th Mile to ect 3 Chak via 68th Mile and Chaudhary Nazeer road	
TITLE:-		
	LIST OF DRAWINGS	

ED. NO.	DATE:-	DESCRIPTION	DRAWN:	N.S.SIDDIQUI	DRAWING NO. SB-2 GEN-02
			DESIGN:	HINA ZEESHAN	Scale:-
			CHECKED:		N.T.S.
			OFFICINED.	NAVEED HASSAN	Edition:-
			DATE:	JUNE, 2023	0

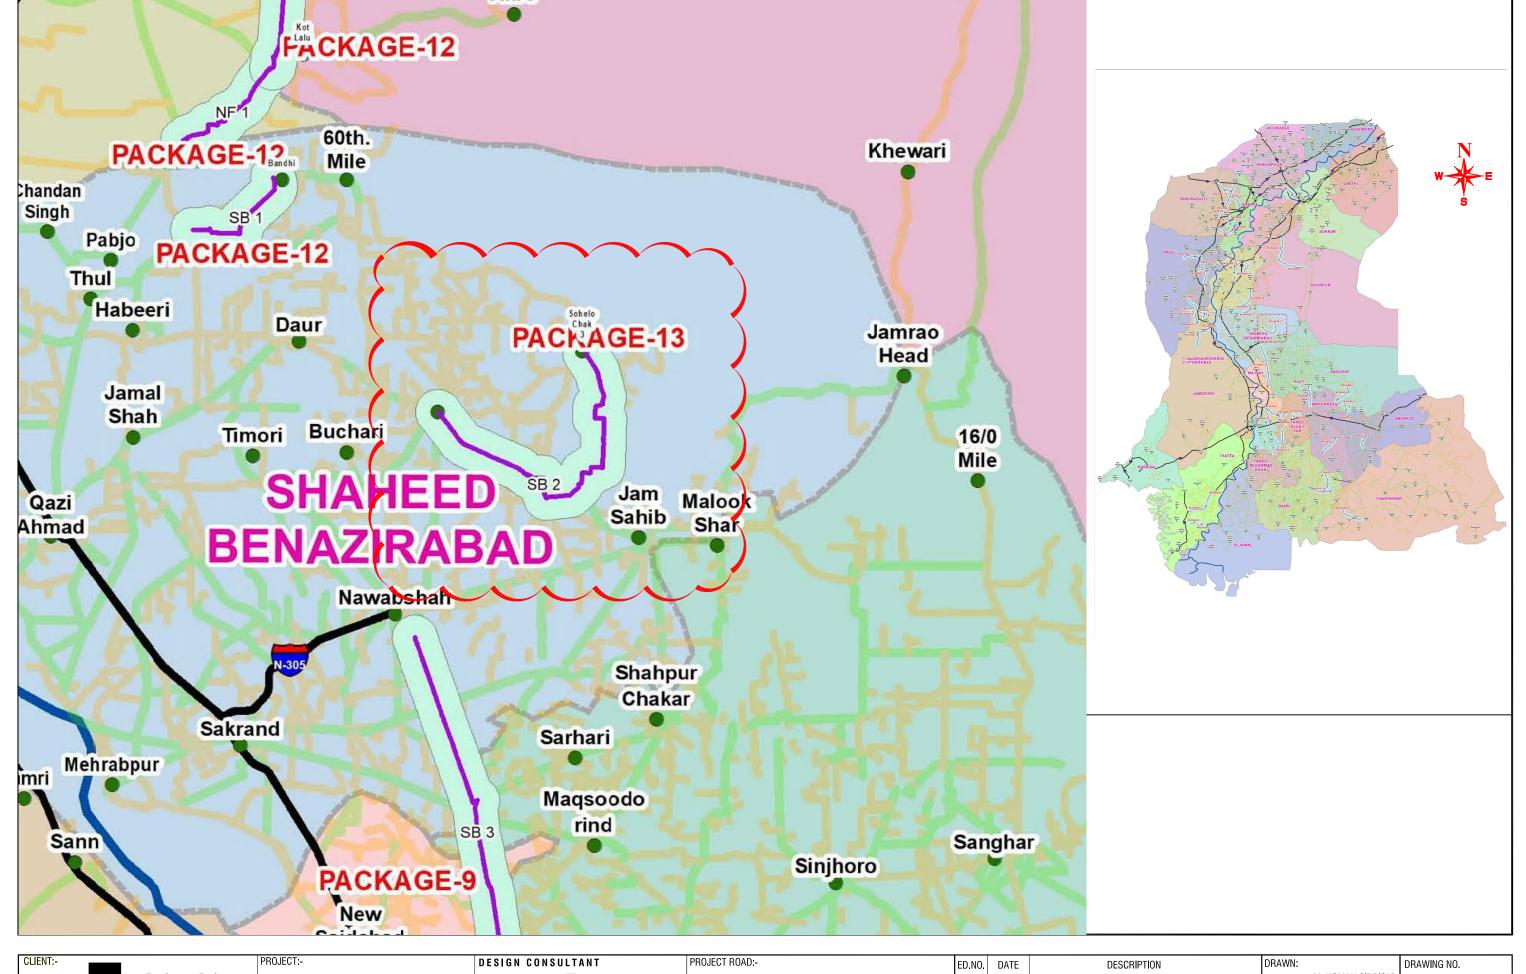

10	LIENT:-	PROJECT:-	DESIGN CONSULTANT	PROJECT ROAD:-	ED.NO. DATE DESCRIPTION	DRAWN:	DRAWING NO.
	ADB Asian Development Bank			PACKAGE - 13		M. NOMAN SIDDIQUI	
		LOAN NO. 4279-PAK (COL): EMERGENCY FLOOD		(SB-2)		DESIGNED:	Cooler
E	XECUTING AGENCY:-	ASSISTANCE PROJECT (EFAP)		TITLE:-		IVAVEED HADAIN	Scale:-
١,	WORKS AND SERVICES DEPARTMENT		in association with	KEY PLAN		CHECKED:	N.T.S. Edition.
	GOVERNMENT OF SINDH			NETT EAN		BUX ALI ABRO DATE: JULY, 2023	0

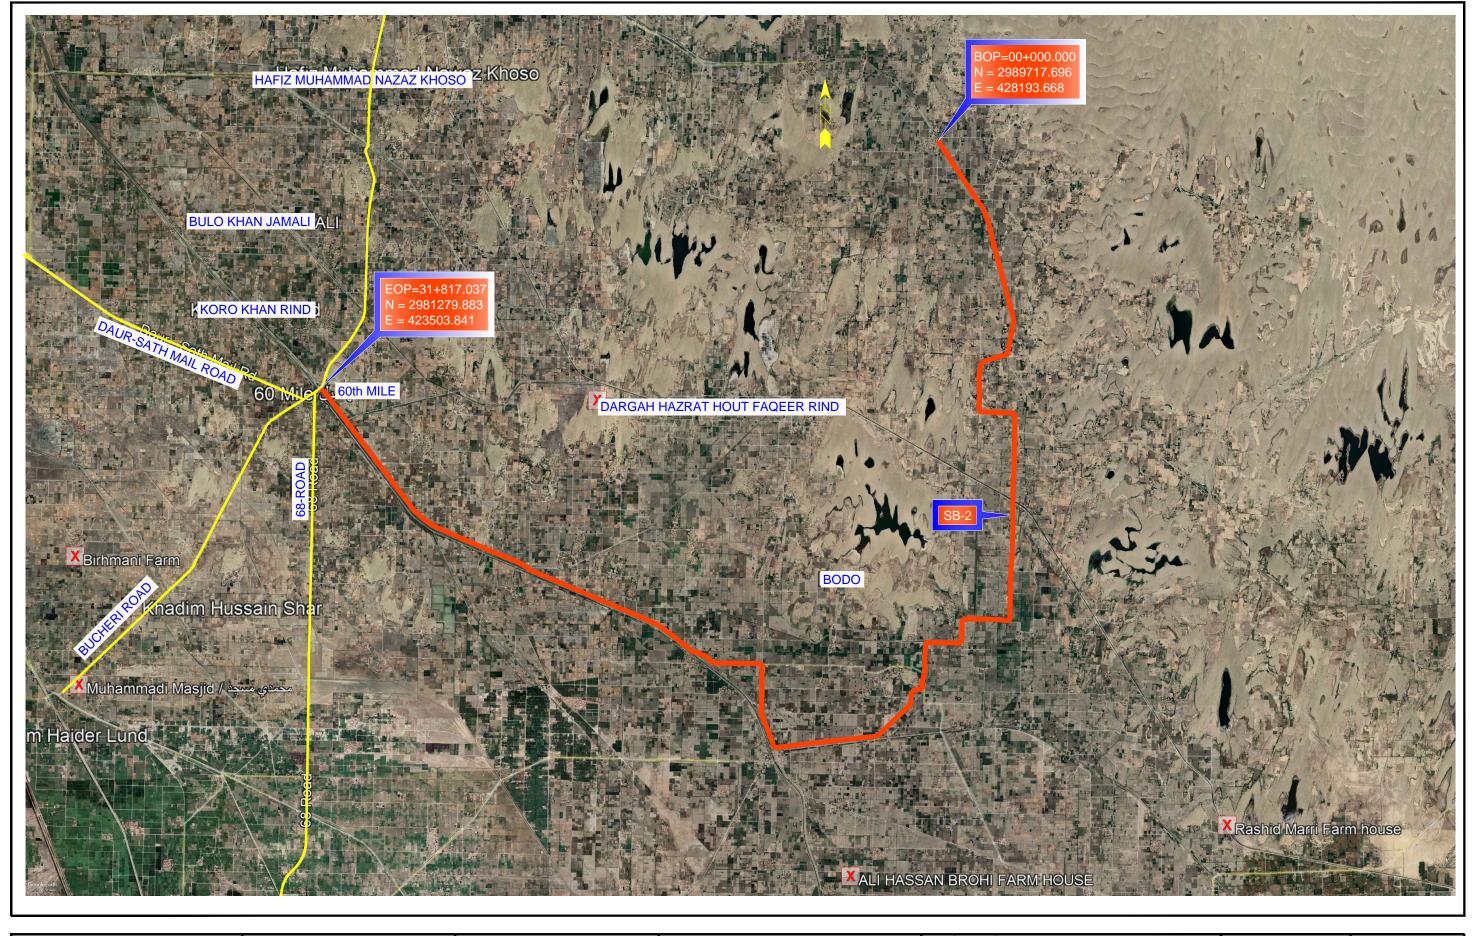

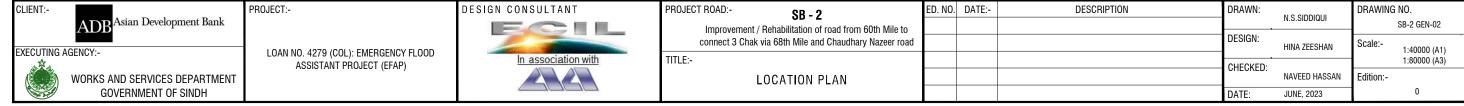

3. ROADWAY PLANS (SCALE 1:1000 FOR A1-SHEET/1:2000 APPROX. FOR A3 SHEET) HAVE BEEN PREPARED FROM THE FIELD SURVEY (CARRIED OUT IN YEAR NOVEMBER-2017) DATA BASED UPON COORDINATES AND LEVELS CONFORM TO SOP PATTERN.

- 4. CROSS SECTIONS OF THE EXISTING AND NEW ROAD HAVE BEEN TAKEN AT INTERVALES OF 25M. OR LESS IF REQUIRED.
- 5. PAVEMENT DESIGN HAS BEEN PREPARED BY CONSULTANTS FOR EXISTING ROAD AND NEW ROAD BASED ON CBR VALUES AND TRAFFIC LOADS AS PER RECOMMENDATIONS UNDER TRL & AASHTO.
- 6. TYPICAL CROSS SECTION HAS BEEN PREPARED FOR EACH PAVEMENT DESIGN/STRATEGY.
- 7. LOCATION OF ALL EXISTING STRUCTURES HAVE BEEN MARKED ON ROADWAY PLAN DRAWINGS.
- 8. QUANTITIES HAVE BEEN CALCULATED FOR EARTH WORK AND OTHER WORK'S ITEMS FOR ESTIMATION PURPOSES.
- 9. BASED ON ROAD SAFETY AUDITS IN FIELD, FOLLOWING DETAILS WITH TYPICAL DESIGNED DRAWINGS HAVE BEEN PROVIDED ACCORDING TO SITE REQUIREMENTS.
 - TRAFFIC SIGNS.
 - PAVEMENT MARKING DETAILS.
 - CROSS SECTION OF PLAIN AND MOUNTANIOUS AREA, DRAIN IN DETAIL.
- 10. ROADWAY PLAN DRAWINGS (1:2000) SHOULD BE READ IN CONJUCTION WITH ROAD FURNITURE DRAWINGS (TYPICAL), STRUCTURES AND DRAINAGE DRAWINGS, ETC.
- 11. ACTUAL QUANTUM OF REHABILITATION WORK FOR EXISTING STRUCTURES SHALL BE DETERMENED BY THE RESIDENT ENGINEER AT THE TIME OF EXECUTION FOR EACH STRUCTURE.
- 12. EXISTING LEVELS, DIMENSIONS AND TOPOGRAPHY REPRESENT CONDITIONS AT THE TIME OF SURVEY DONE IN NOVEMBER-2017.
- 13. EACH DRAWING SHALL BE READ IN CONJUNCTION WITH OTHER DRAWINGS, WHERE NECESSARY.
- 14. NOTES GIVEN ON DRAWINGS ADJACENT TO A SECTION PERTAIN TO THE PARTICULAR DFTAIL.
- 15. THE SOAKED C.B.R OF EMBANKMENT MATERIAL SHALL NOT BE LESS THAN 10% AT MODIFIED AASHTO DENSITY IN ACCORDANCE WITH COMPACTION ZONE OF EMBANKMENT AS SPECIFIED.

- 16. THE SUBGRADE MATERIAL/WHERE USED, SHALL HAVE A MINIMUM C.B.R. (SOAKED) OF 20% AT 95% M.D.D. AASHTO T-180.
- 17. BEFORE STARTING PAVEMENT MARKING, CONTRACTOR SHALL SUBMIT WORKING DETAILS SHOWING EXACT LOCATION, TYPE AND SIZE OF MARKING FOR APPROVAL OF ENGINEER.
- 18. FOR AVOIDING ABRUPT CHANGE IN PROFILE AT BOP AND EOP OVERLAY IS TO BE REDUCED GRADUALLY BEFORE BOP AND AFTER EOP TO MATCH THE ADJOINING PROFILE IN TRANSITION WITHIN 30 TO 40 M. LENGTH WITHOUT FORMING ANY KINK AS SHOWN ON DRAWINGS OR AS DIRECTED BY THE RESIDENT ENGINEER. FOR ALL SECTIONS AND STRETCHES.
- 19. THE CONTRACTOR SHALL BE RESPONSIBLE FOR PROVISION OF DIVERSIONS FOR TRAFFIC AND ITS MANITENANCE, SIGNS AND ALL SAFETY MEASURES DURING THE CONSTRUCTION AT NO ADDITTIONAL COST TO THE CLIENT.
- 20. THE EMBANKMENT SLOPES SHALL BE TRIMMED AND DRESSED TO DESIGN LINE AS SHOWN ON DRAWINGS.
- 21. ANY DAMAGE DONE TO THE UTILITIES DURING EXCAVATION/EXECUTION OF WORK SHALL BE REPAIRED BY THE CONTRACTOR AT NO EXTRA COST TO THE CLIENT.
- 22. CONTRACTOR SHALL BE RESPONSIBLE FOR ALL DIVERSIONS OF WATER AT STRUCTURES LOCATIONS INCLUDING DYKES AND TRENCHES ETC. WITHOUT ANY ADDITIONAL COST.
- 23. THE ROAD CONSTRUCTION SHALL BE PLANNED IN A MANNER THAT A MAXIMUM STRETCH OF 3-4 Km SHALL BE TAKEN IN HAND FOR CONSTRUCTION AT A TIME, AND TRAFFIC IS PROVIDED WITH A PROPER AND WELL MAINTAINED DIVERSION.
- 24. THE EXISTING LOCALIZED HUMPS SHALL REQUIRED REMOVAL AND TREATMENT AS PER THE SITE CONDITIONS FOR ACCOMMODATING FULL PAVEMENT THICKNESSES AS DIRRECTED BY THE ENGINEER.
- 25. LOCATION OF UNDER GROUND CABLES/UTILITIES SHOWN ON PLANS ARE APPROXIMATE. EXACT LOCATION SHALL BE DETERMINED BY THE CONTRACTOR AT NO EXTRA COST.
- 26. SUBGRADE IN CUT:

GENERAL NOTES

- i) IN CUT AREAS (COMMON SOILS) SUBGRADE SOILS (TOP 300mm) MUST BE EXCAVATED, RELAID AND COMPACTED IN LAYERS (EACH 150mm THICK) TO THE SPECIFIED DENSITY AND MUST MEET THE MATERIAL REQUIREMENT FOR CLASSIFICATION, PLASTICITY INDEX (PI) AND SOAKED CBR 25%. THE UNSUITABLE SOILS IF OBTAINED FROM EXCAVATION SHALL BE DISPOSED OFF AND REPLACED WITH SUITABLE SOILS MEETING THE REQUIREMENT OF SUB GRADE/COMPACTED FILL MATERIAL CBR ≥ 25%.
- ii) IN ROCK CUT THE EXCAVATION LIMIT LINE SHALL BE AT THE BOTTOM LEVEL OF SUBBASE COURSE.
- iii) IN ROCK CUT AREAS (UNSUITABLE MATERIALS LIKE SHALE) THE EXCAVATION LIMIT LINE SHALL BE 300mm BELOW THE BOTTOM LEVEL OF SUBBASE COURSE. THIS DEPTH OF 300mm SHALL BE REPLACED WITH SUITABLE SOILS MEETING THE REQUIREMENT OF SUB GRADE/ COMPACTED FILL MATERIAL CBR ≥ 25%.
- 27. PRECAST CONCRETE/METAL GUARD RAIL IS TO BE PROVIDED WHERE FILL HEIGHT EXCEED 3.00M OR AS DIRECTED BY THE ENGINEER.

CLIENT:-EXECUTING AGENCY:-WORKS AND SERVICES DEPARTMENT

ADB²

Asian Development Bank

GOVERNMENT OF SINDH

PROJECT:-

LOAN NO. 4279-PAK (COL): EMERGENCY FLOOD ASSISTANCE PROJECT (EFAP)



PROJECT ROAD:-	ED.NO.	DATE	DESCRIPTION	DRAWN:		DRAWING NO.
					N. SAQIB SIDDIQUI	GEN-03
				DESIGNED:		Scale:-
TITLE:-					HINA ZEESHAN	
	\vdash			CHECKED:		N.T.S.
GENERAL NOTES					NAVEED HASSAN	Edition.
				DATE:	JUNE. 2023	0

SYMBOLS EXISTING ROAD TRACK / PATH PROPOSD ROAD PROPOSED ALIGNMENT PROPOSD ALLIGNMENT PROPOSD CULVERTS PIPE CULVERT RIGHT OF WAY HIGH TENSION LINE LTL ____LTL ____LTL __ LOW TENSION LINE ELECTRIC POLE, ELECTRIC WIRE TELEPHONE WIRE TELEPHONE POLE, TELEPHONE WIRE FIBRE OPTIC CABLE PL PL PL PIPE LINE WATER COURSE BUILDING AND OTHER STRUCTURES MASJID HAND PUMP / TUBE WELL GPS CONTROL POINTS BENCH MARK LIGHT POLE-LP

SYMBOLS

EXISTING BUND

CANAL / WAH

TREES

BUND
TOE

TRACK

CANAL

TRACK

GRAVE YARD GRAVE YARD

POND PONG:

RAILWAY LINE RAILWAY LINE

P.I. STATION

ABBREVIATIONS

GENERAL

B.O.P	BEGENING OF PROJECT
BM	BENCH MARK
CL	CENTRE LINE
CM	CUBIC METER
Cm	CENTIMETER
D.S.T	DOUBLE SURFACE TREATMENT
DRG.	DRAWING
D/S	DOWN STREAM
E	EAST, EASTING, EXTERNAL DISTANCE
E.O.P.	END OF PROJECT
F.R.L	FINISHED ROAD LEVEL
H.F.L	HIGH FLOOD LEVEL
KM	KILOMETRE
LT	LEFT
RT	RIGHT
I.L	INVERT LEVEL

ABBREVIATIONS

GENERAL

M	METRE
MH	MAN HOLE
mm	MILLIMETRE
N	NORTH, NORTHING
N.G.L	NATURAL GROUND LEVEL / EXISTING LEVEL
I.T.S	NOT TO SCALE
RD	REDUCED DISTANCE
RH	RIGHT HAND CURVE
R.O.W	RIGHT OF WAY
STA	STATION
TR	TRAVERSE STATION
U/S	UP SREAM
wc	WATER COURSE

HORIZONTAL CURVE

P.I.#POINT OF INTERSECTION NUMBER
DEFLECTION ANGLE
R RADIUS
T TANGENT LENGTH
E EXTERNAL ORIDINATE
L LENGTH OF CURVE / ARC LENGTH
C CHORD LENGTH
M MIDDLE ORIDINATE
PC POINT OF CURVATURE
PT POINT OF TANGECY


VERTICAL CURVE

STA	RD. AT VERTICAL POINT OF INTERSECTION
VPC	VERTICAL POINT OF CURVATURE
VPT	VERTICAL POINT OF TANGENCY
EL	ELEVATION AT VERTICAL POINT OF INTERSECTION
CURVE LEN	LENGTH OF VERTICAL CURVE
E	EXTERNAL DISTANCE
κ	RATE OF VERTICAL CURVATURE / K FACTOR
F.R.L	FINISHED ROAD LEVEL AT PROFILE GRADE
RD.	REDUCED DISTANCE

SUPERELEVATION

SUPERELEVATION	%
SR	SUPERELEVATION RUN OFF LENGTH
TR	TANGENT RUNOUT LENGTH
TRAN	TRANSITION
STRAIGHT	NORMAL CROSS SLOPE

CLIENT:-	PROJECT:-	DESIGN CONSULTANT	PROJECT ROAD:-	ED.NO.	DATE	DESCRIPTION	DRAWN:		DRAWING NO.
ADB ^{Asian Development Bank}							DECIONED	N. SAQIB SIDDIQUI	GEN-04
EXECUTING AGENCY:-	LOAN NO. 4279-PAK (COL): EMERGENCY FLOOD						DESIGNED		Scale:-
a ka	ASSISTANCE PROJECT (EFAP)	In association with	TITLE:-				CHECKED		N.T.S.
WORKS AND SERVICES DEPARTMENT			SYMBOLS AND ABBREVIATIONS				1	NAVEED HASSAN	Edition.
GOVERNMENT OF SINDH							DATE:	JUNE, 2023	1 0

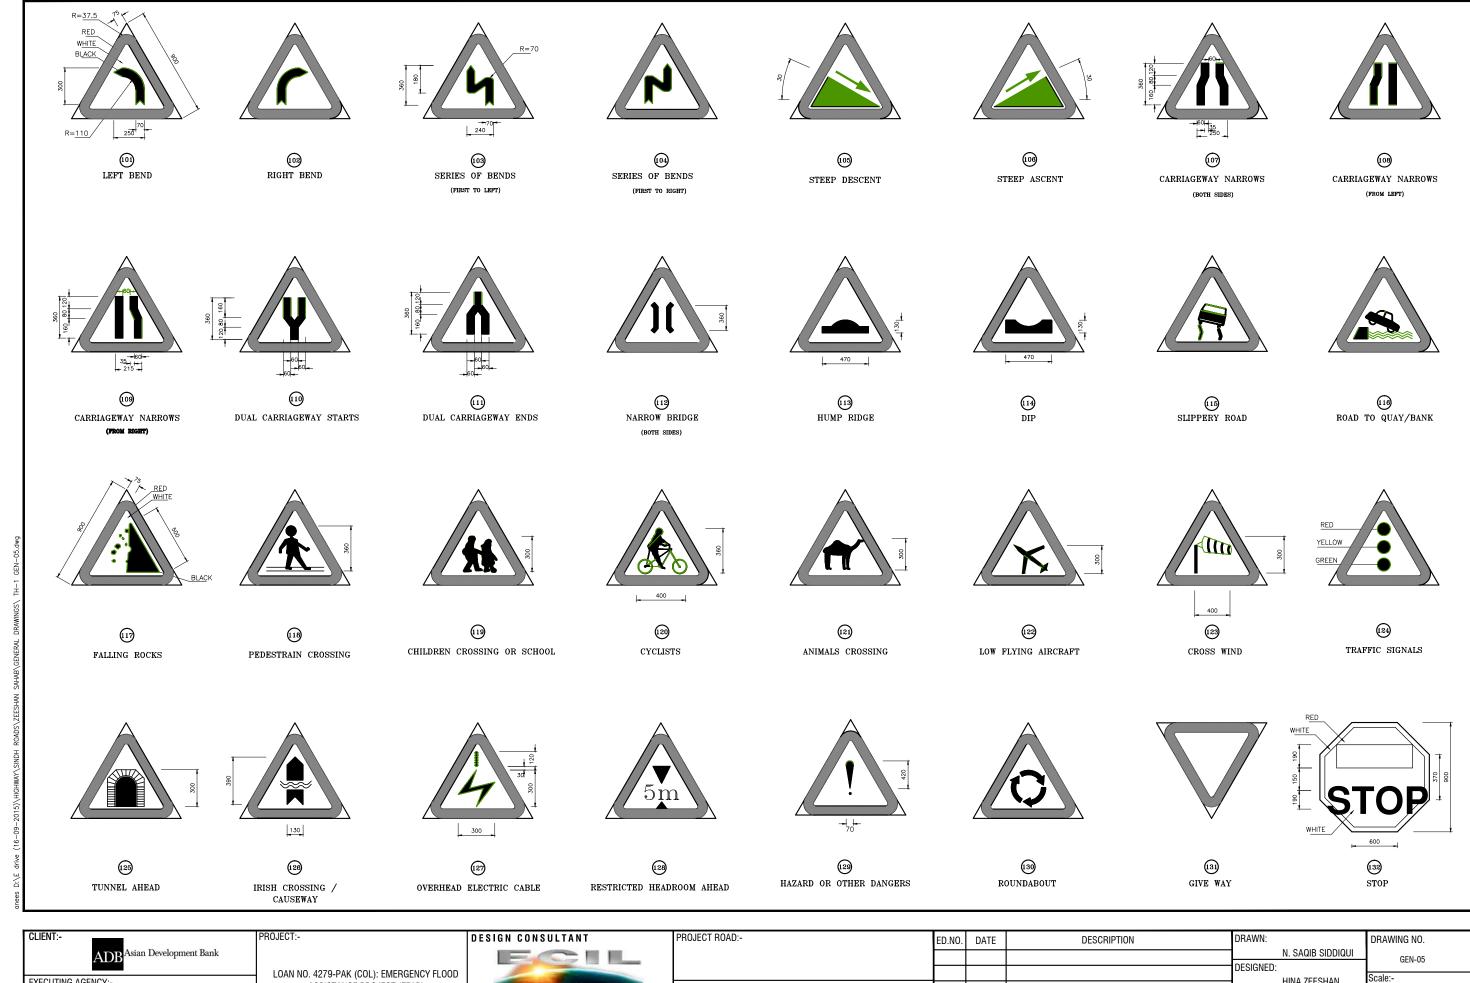

ADB Asian Development Bank

EXECUTING AGENCY:WORKS AND SERVICES DEPARTMENT GOVERNMENT OF SINDH

PROJECT: DESCRIPTION

DESIGN CONSULTANT
PROJECT ROAD:PROJECT ROAD:PROJECT ROAD:PROJECT ROAD:PROJECT ROAD:PROJECT ROAD:PROJECT ROAD:DESIGN CONSULTANT
PROJECT ROAD:DESIGN CONSULTANT
PROJECT ROAD:
DESCRIPTION

N. SAQIB SIDDIQUI
OEN-05

Scale:TYPICAL ROAD SIGNS
(SHEET 1 OF 3)


DATE: JUNE, 2023


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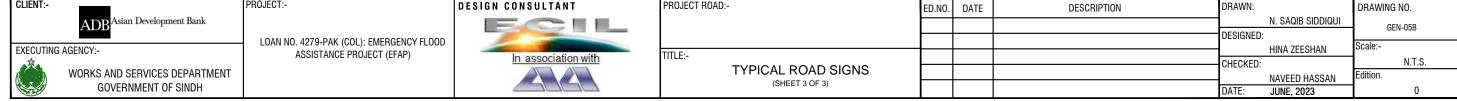
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DATE: JUNE, 2023


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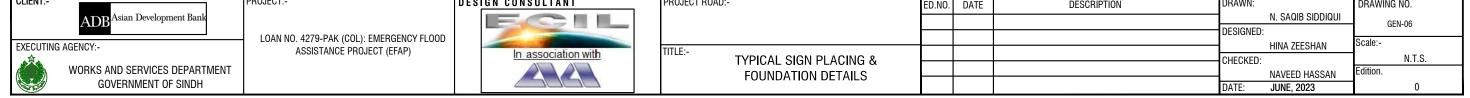
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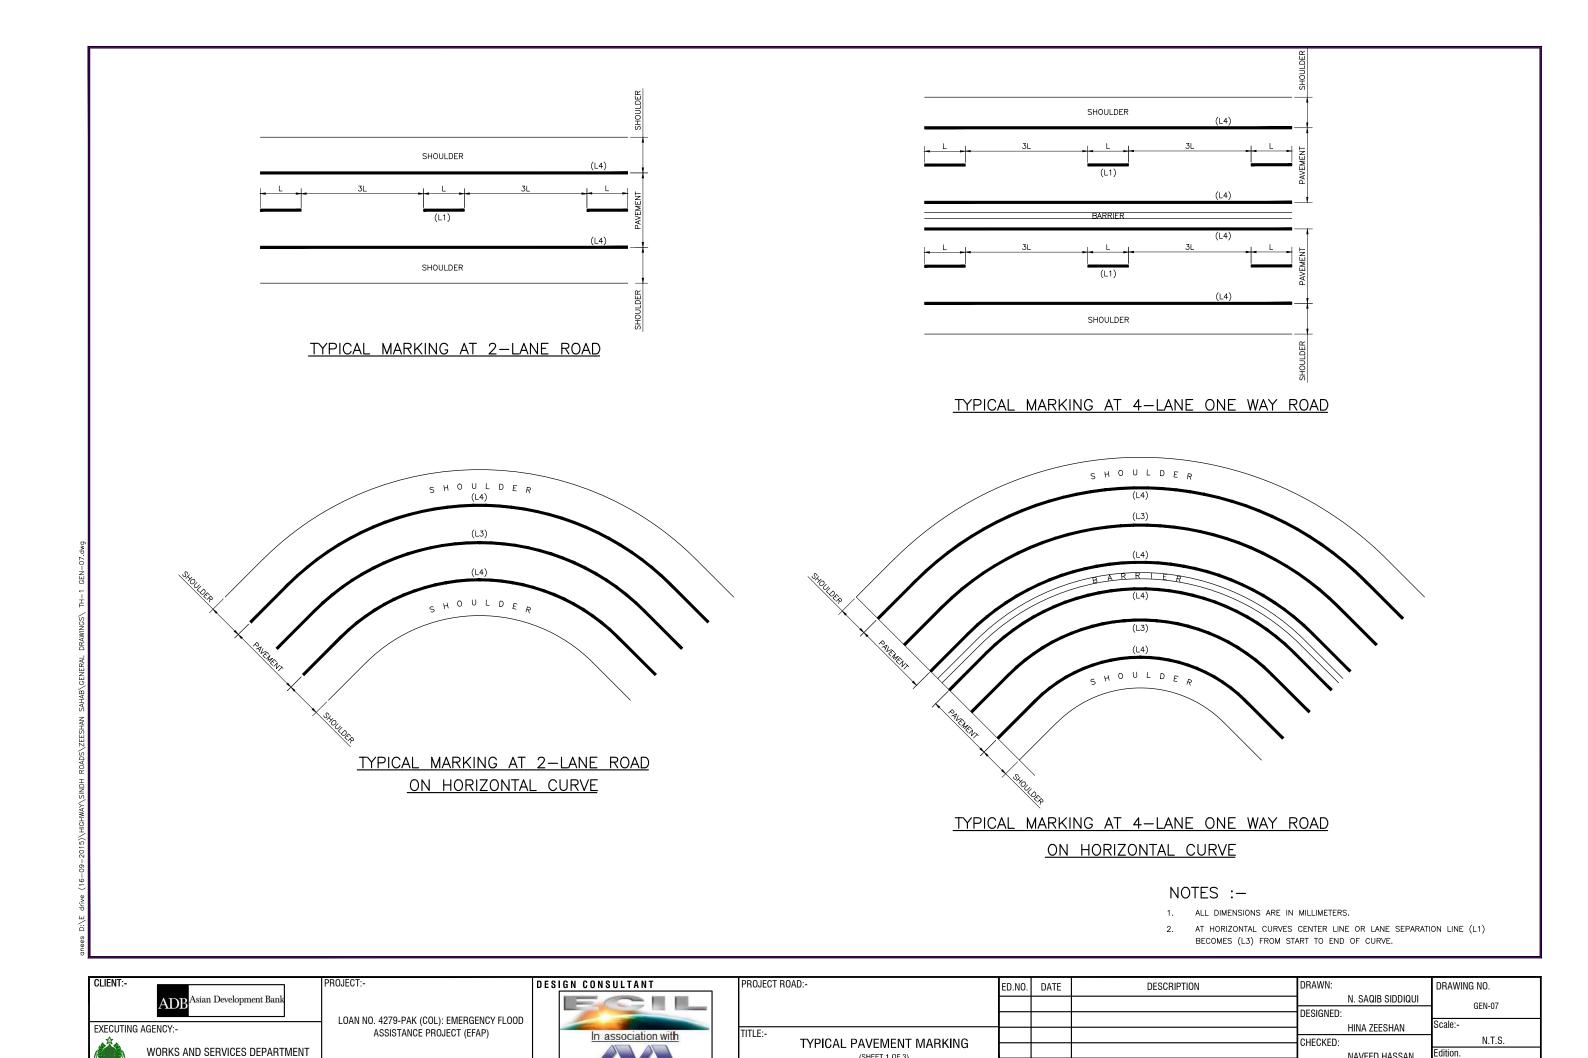






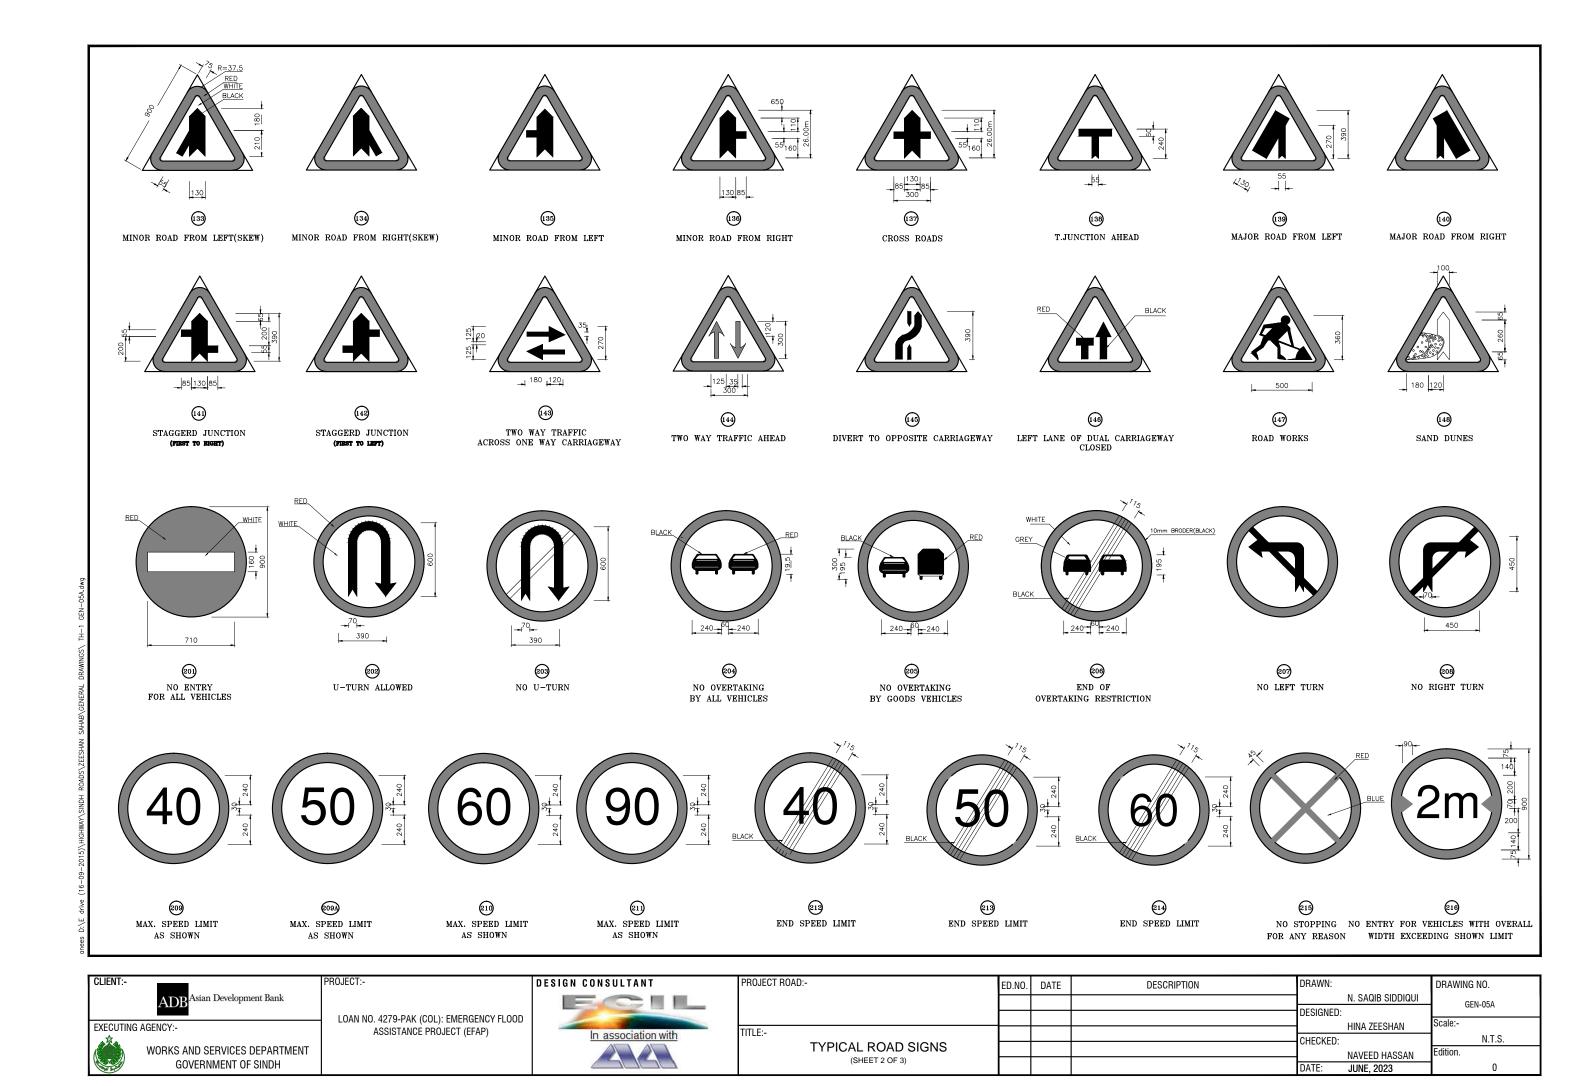

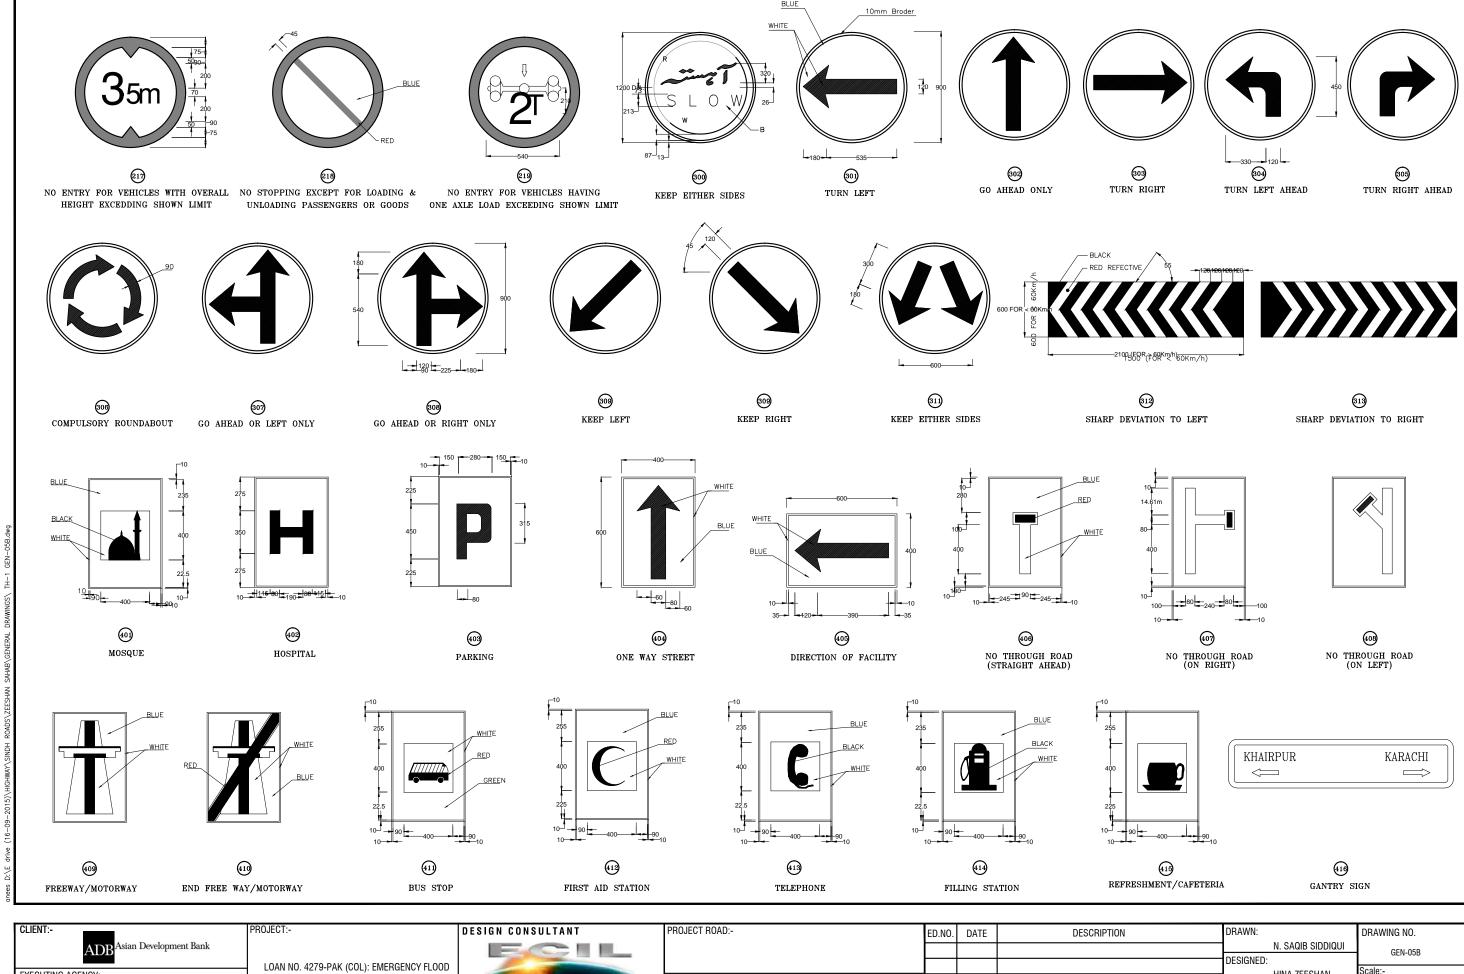

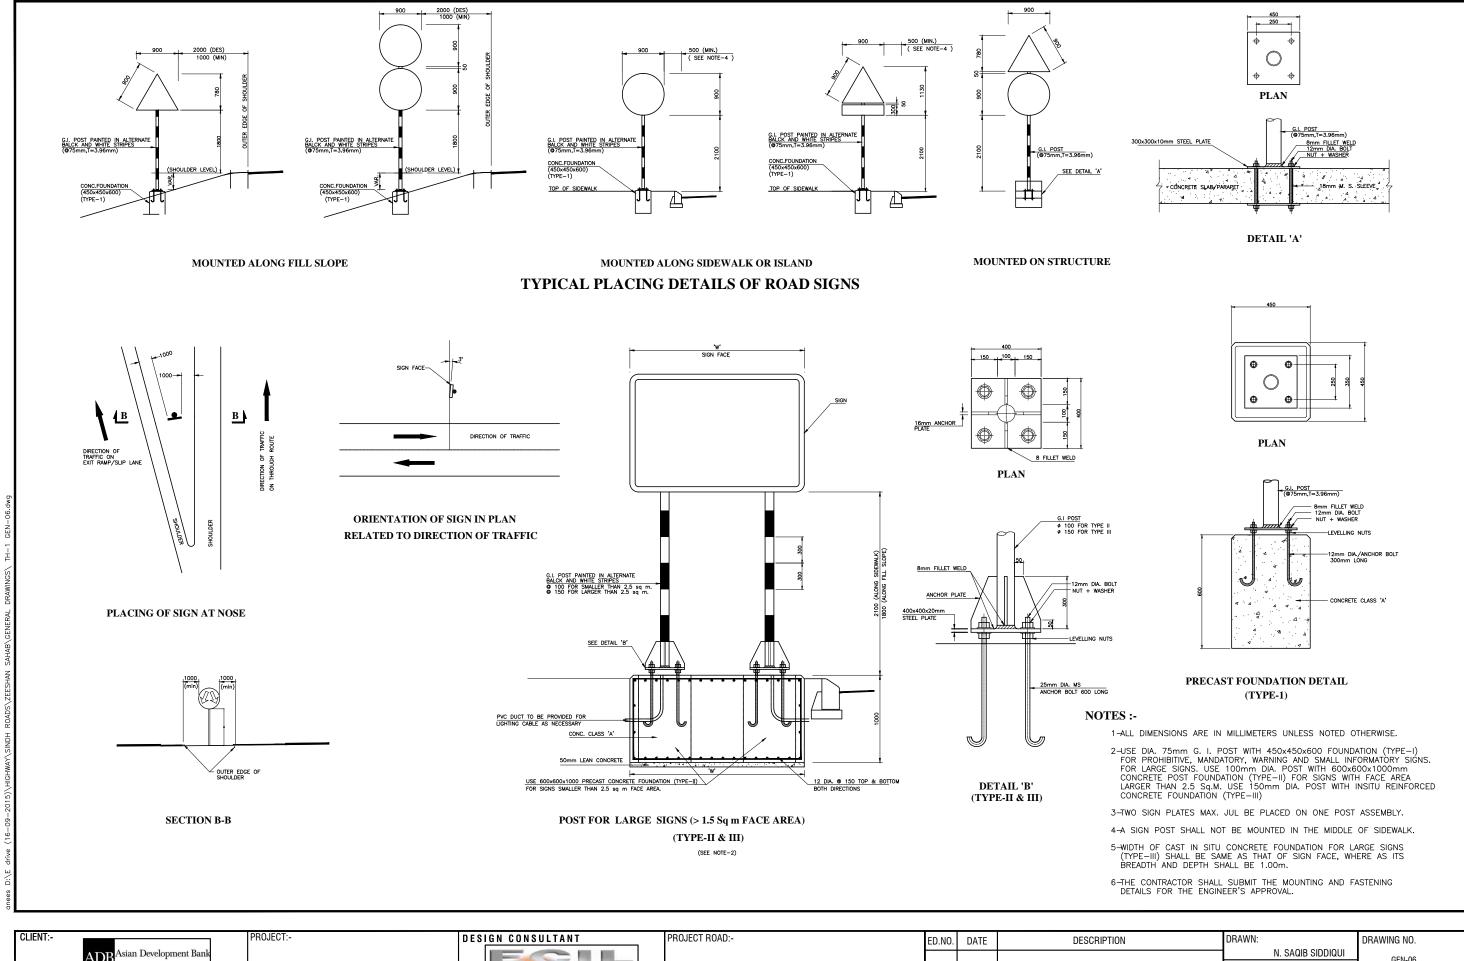

(SHEET 1 OF 3)


GOVERNMENT OF SINDH


Edition.

NAVEED HASSAN


JUNE, 2023

DATE:

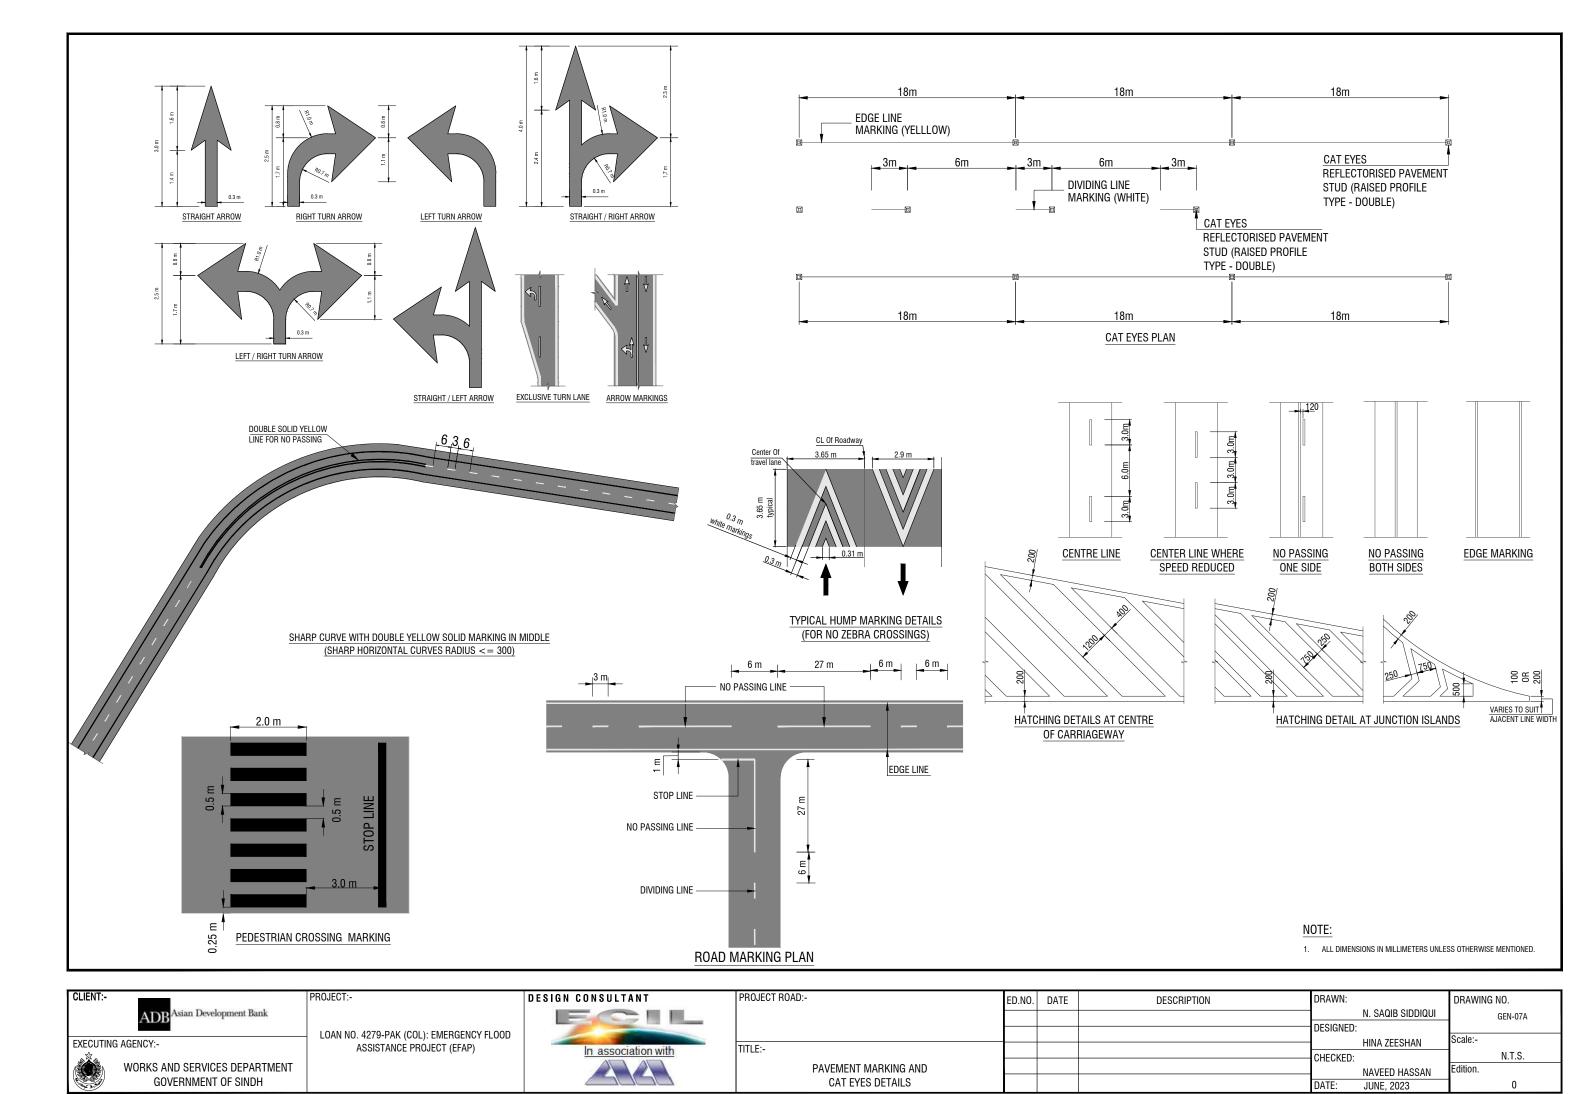

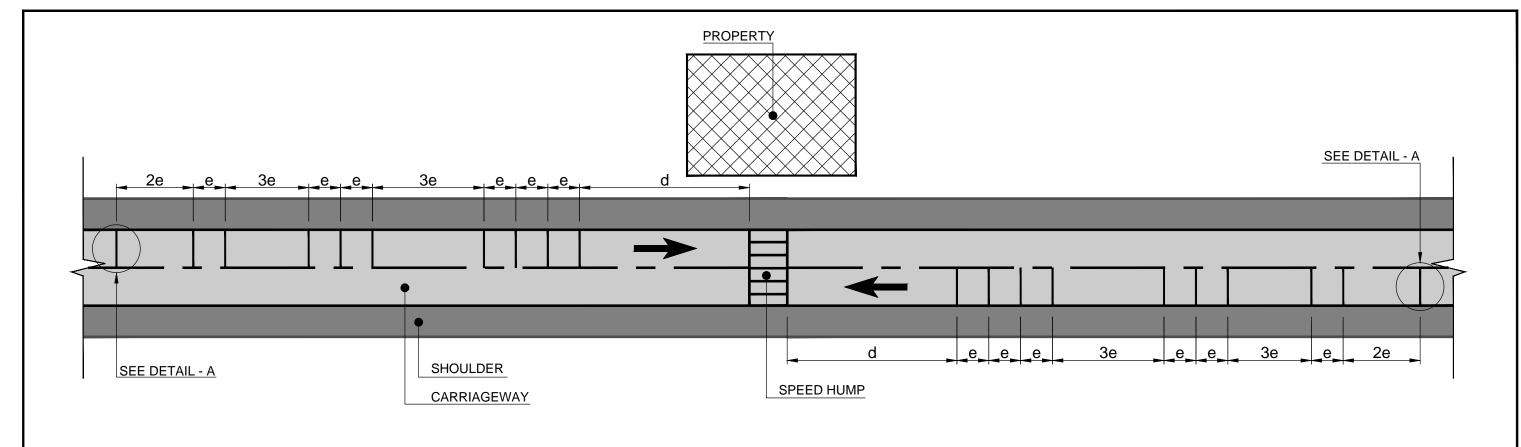


PLAN OF TRANSVERSE RUMBLE STRIPS

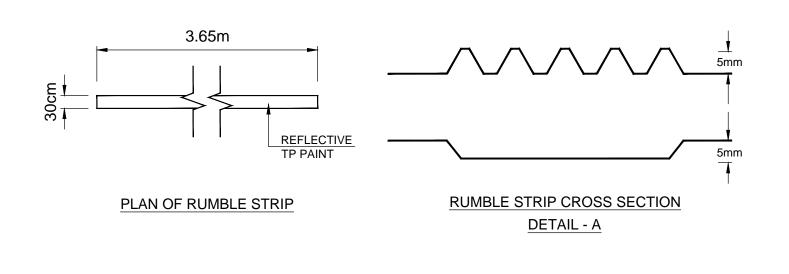


NOTES:-

- $\ensuremath{\mathsf{1}}$ ALL DIMENSIONS ARE IN MILLIMETERS, EXCEPT OTHERWISE MENTIONED.
- 2 SPEED HUMPS/RUMBLE STRIPS WILL BE PROVIDED NEAR AMENITIES SUCH AS MOSQUES, PLAYGROUNDS, SCHOOLS, HOSPITALS, ETC, FOR TRAFFIC CALMING AS PER DECISION OF THE ENGINEER.

CLIENT:-	PROJECT:-	DESIGN CONSULTANT	PROJECT ROAD:-	ED.NO. DATE	DESCRIPTION		DRAWING NO.
ADB ^{Asian} Development Bar						N. SAQIB SIDDIQUI DESIGNED:	GEN-07B
EXECUTING AGENCY:-	LOAN NO. 4279-PAK (COL): EMERGENCY FLOOD ASSISTANCE PROJECT (EFAP)		TITLE.				Scale:-
4 章。	· · ·	In association with	TITLE:-			CHECKED:	N.T.S.
WORKS AND SERVICES DEPAR	I		RUMBLE STRIP DETAILS			INAVELD HASSAN	Edition.
GOVERNMENT OF SINDH	I		HOMBLE OTHER BETTHEO			DATE: JUNE, 2023	0

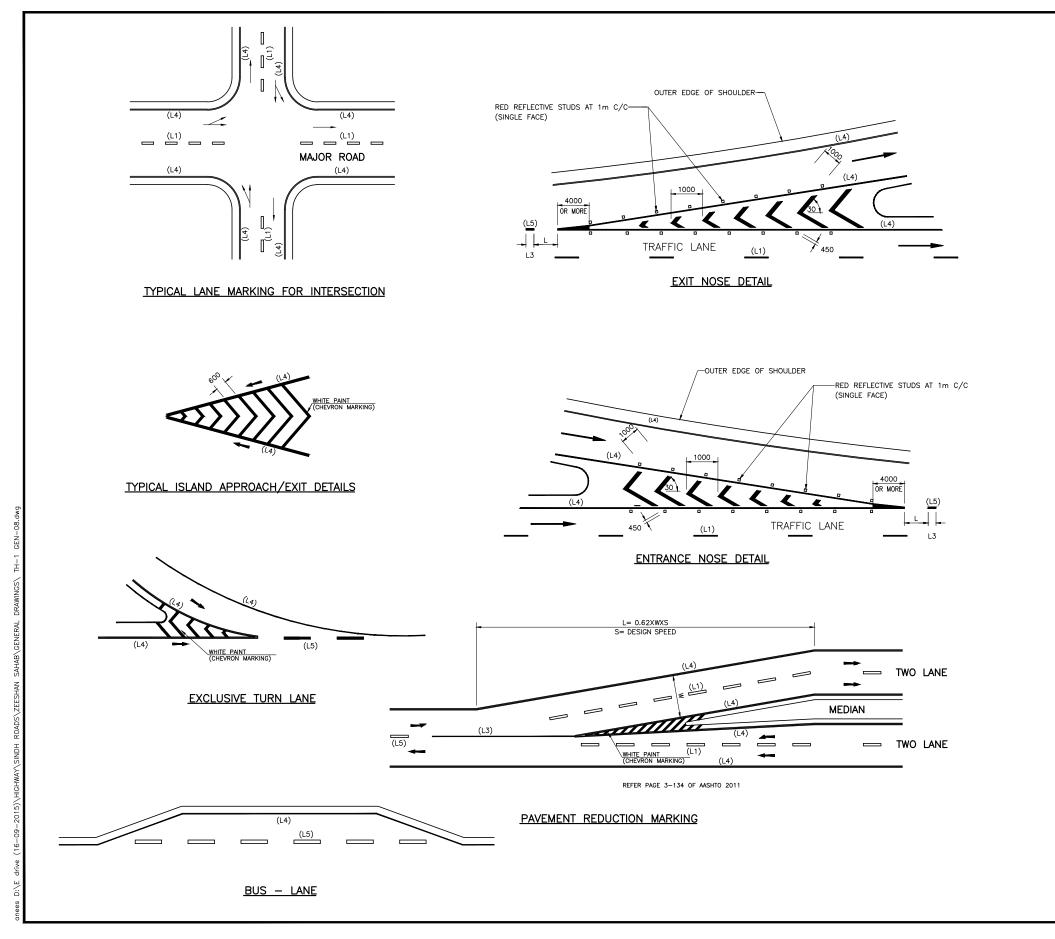

PLAN

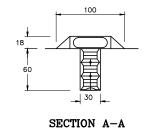


REFLECTORISED PAVEMENT STUD (RAISED PROFILE TYPE)

SCALE NTS

NOTES:


- 1) THE MATERIAL TO BE USED FOR CARRIAGEWAY MARKINGS SHALL BE OF APPROVED TYPE AND QUALITY.
- PROPER VISIBILITY OF ALL SIGNS & MARKINGS AT ALL TIMES DURING THE DAY AND NIGHT SHALL BE ENSURED.
- 3) ROAD STUDS SHALL ALSO BE PROVIDED AT INTERSECTIONS AS SHOWN ON PLANS AND AS DIRECTED BY THE ENGINEER.

CLIENT:-		PROJECT:-	DESIGN CONSULTANT	PROJECT ROAD:-	ED.NO.	DATE	DESCRIPTION	DRAWN:		DRAWING NO.
	ADB Asian Development Bank							DECIONED	N. SAQIB SIDDIQUI	GEN-08
EVECUTIV	G AGENCY:-	LOAN NO. 4279-PAK (COL): EMERGENCY FLOOD						DESIGNED		Scale:-
EXECUTION	G AGENCY	ASSISTANCE PROJECT (EFAP)	In association with	TITLE:-				CHECKED:	TIINA ZEESTIAN	N.T.S.
	WORKS AND SERVICES DEPARTMENT			DETAILS OF MERGING/DIVERGING				OTILOTED.	NAVEED HASSAN	Edition.
	GOVERNMENT OF SINDH							DATE:	JUNE, 2023	0

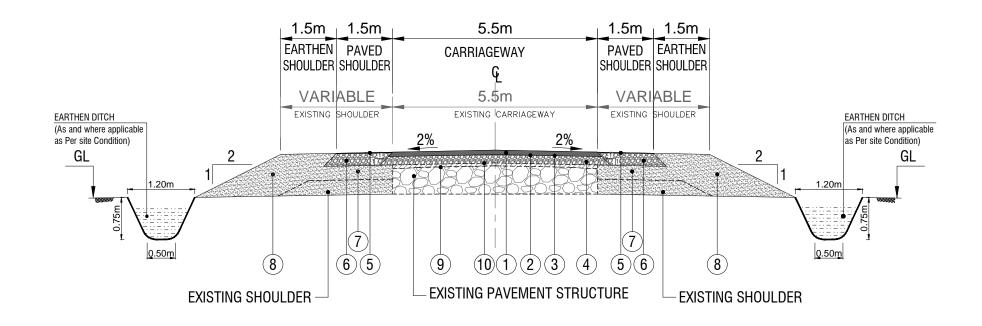


NOTES:-

- . ASPHALT CONCRETE WEARING COURSE (CLASS A) 5cm
- 2. TACK COAT.
- 3. SINGLE SURFACE TREATMENT.
- 4. WATER BOUND MACADAM25cm
- 5. TRIPLE SURFACE TREATMENT.
- 6. WATER BOUND MACADAM 15cm.
- EARTHEN SHOULDER.
- 9. EXISTING ROAD BITUMINOUS SURFACING IS TO BE SCARIFIED AND REMOVED THE EXPOSED SURFACE AFTER SCARIFICATION SHALL BE COMPACTED TO SPECIFIED DENSITY.
- 10. IN STRETCHES / SEGMENTS WHERE THERE IS NO EXISTING BITUMINOUS SURFACING AS THE SAME HAS BEEN WORN OUT, SKIN PATCHES OF TRANSPORTED CONTAMINATED SOIL IS TO REMOVED FROM SURFACE AND COMPACTED TO SPECIFIED DENSITY.
- 11. ALL DIMENSIONS ARE IN METER EXCEPT OTHER WISE MENTIONED.
- * REMOVAL OF BRICK EDGING SHALL BE CARRIED OUT AND PAID IN SHOULDER EXCAVATION

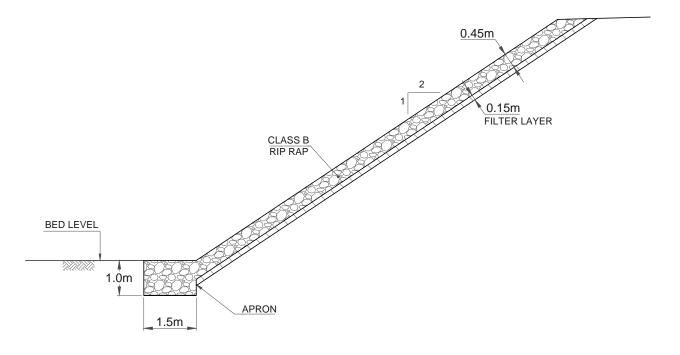

TYPICAL SECTION OF PROTECTION WORKS

CLIENT:-		PROJECT:-	DESIGN CONSULTANT	PROJECT ROAD:- SB - 2	ED.NO.	DATE	DESCRIPTION		DRAWING NO.
	ADB Asian Development Bank			Improvement / Rehabilitation of road from 60th mile to				M. NOMAN SIDDIQUI DESIGNED:	SB-2
EXECUTING A	AGENCY:-	LOAN NO. 4279-PAK (COL): EMERGENCY FLOOD ASSISTANCE PROJECT (EFAP)	In association with	connect 3 Chak via 68th mile and Chaudhary Nazeer road TITLE:-				ANDLEEB	Scale:-
	WORKS AND SERVICES DEPARTMENT	(2,	in association with	TYIPCAL CROSS SECTION 0+000 TO END				CHECKED: BUX ALI ABRO	N.T.S. Edition.
	GOVERNMENT OF SINDH			REHABILITATION (5.5m)				DATE: JULY, 2023	0

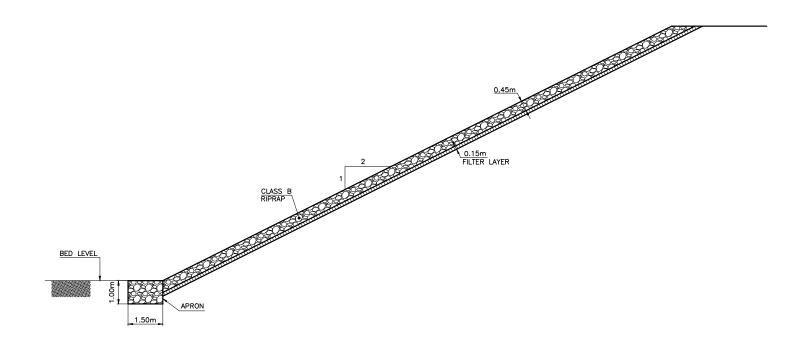


NOTES :-

 PROTECTION WORK SHALL BE APPLICABLE ON REACHES WHICH WILL BE IDENTIFIED IN THE HYDROLOGY REPORT AND AROUND ENTRY AND EXIT OF CULVERT/BRIDGES.

2. ALL DIMENSIONS ARE IN METERS EXCEPT OTHERWISE MENTIONED.

	TENTATIVE	SCHEDULE	
FROM	ТО	SIDE	REMARKS
-	-	-	-

(CLIENT:-	PROJECT:-	DESIGN CONSULTANT	PROJECT ROAD:- SB - 2	ED. NO. DATE:-	DESCRIPTION	DRAWN:	N CAOID CIDDIOLII	DRAWING NO.
	ADB Asian Development Bank			Improvement / Rehabilitation of road from 60th Mile to				N.SAQIB SIDDIQUI	PW-SB-2
	EVECUTING A CENOV	1 0 A N N D 4 4 7 D 4 0 O L) FM F D O FN O V F I 0 O D		connect 3 Chak via 68th Mile and Chaudhary Nazeer road			DESIGN:	HINA ZEESHAN	Scale:-
Į.	EXECUTING AGENCY:-	LOAN NO. 4279 (COL): EMERGENCY FLOOD ASSISTANT PROJECT (EFAP)	In association with	TITLE:-			CHECKED:		N.T.S.
	WORKS AND SERVICES DEPARTMENT	` ,		PROTECTION WORK SCHEDULE			CHECKED.	NAVEED HASSAN	Edition:-
	GOVERNMENT OF SINDH						DATE:	JUNE, 2023	0

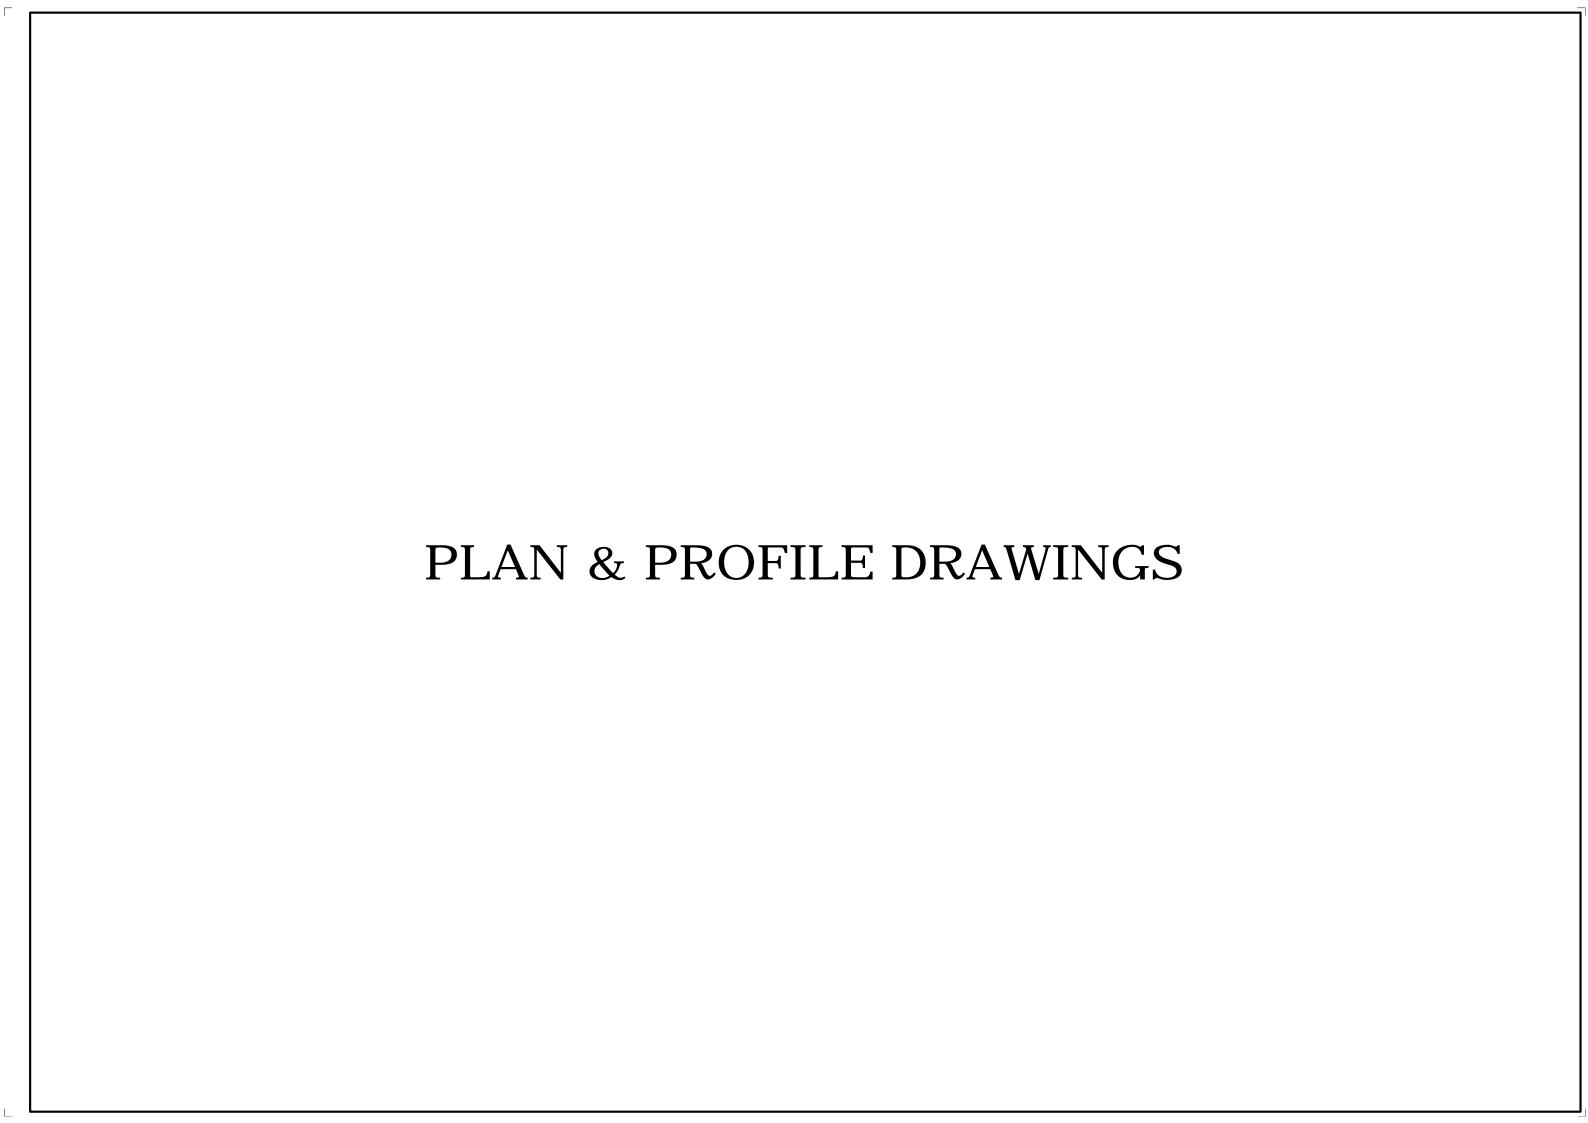

EXECUTING AGENCY:

WORKS AND SERVICES
DEPARTMENT
GOVERNMENT OF SINDH


LOAN NO. 4279-PAK (COL): EMERGENCY FLOOD ASSISTANCE PROJECT (EFAP)




PROJECT ROAD:-		
THOUSE THOMB!	SB-02	
IMPROVEMENT / F	REHABILITATION OF ROAD FROM 60th MILE TO	
CONNECT 3 CHAK	vie 68th MILE AND CHAUDHARY NAZEER ROAD	
TITLE:-	PLAN & PROFILE OF	

SB-02 CH: 0+000 TO 1+000

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SB-02
IMPROVEMENT / REHABILITATION OF ROAD FROM 60th MILE TO DESIGNED: CONNECT 3 CHAK vie 68th MILE AND CHAUDHARY NAZEER ROAD LOAN NO. 4279-PAK (COL): EMERGENCY FLOOD Scale:-EXECUTING AGENCY:-HINA ZEESHAN H=1:2000 V=1:20 ASSISTANCE PROJECT (EFAP) TITLE:-In association with WORKS AND SERVICES PLAN & PROFILE OF CHECKED: DEPARTMENT SB-02 CH: 1+000 TO 2+000 Edition. NAVEED HASSAN **GOVERNMENT OF SINDH** DATE: JULY, 2023

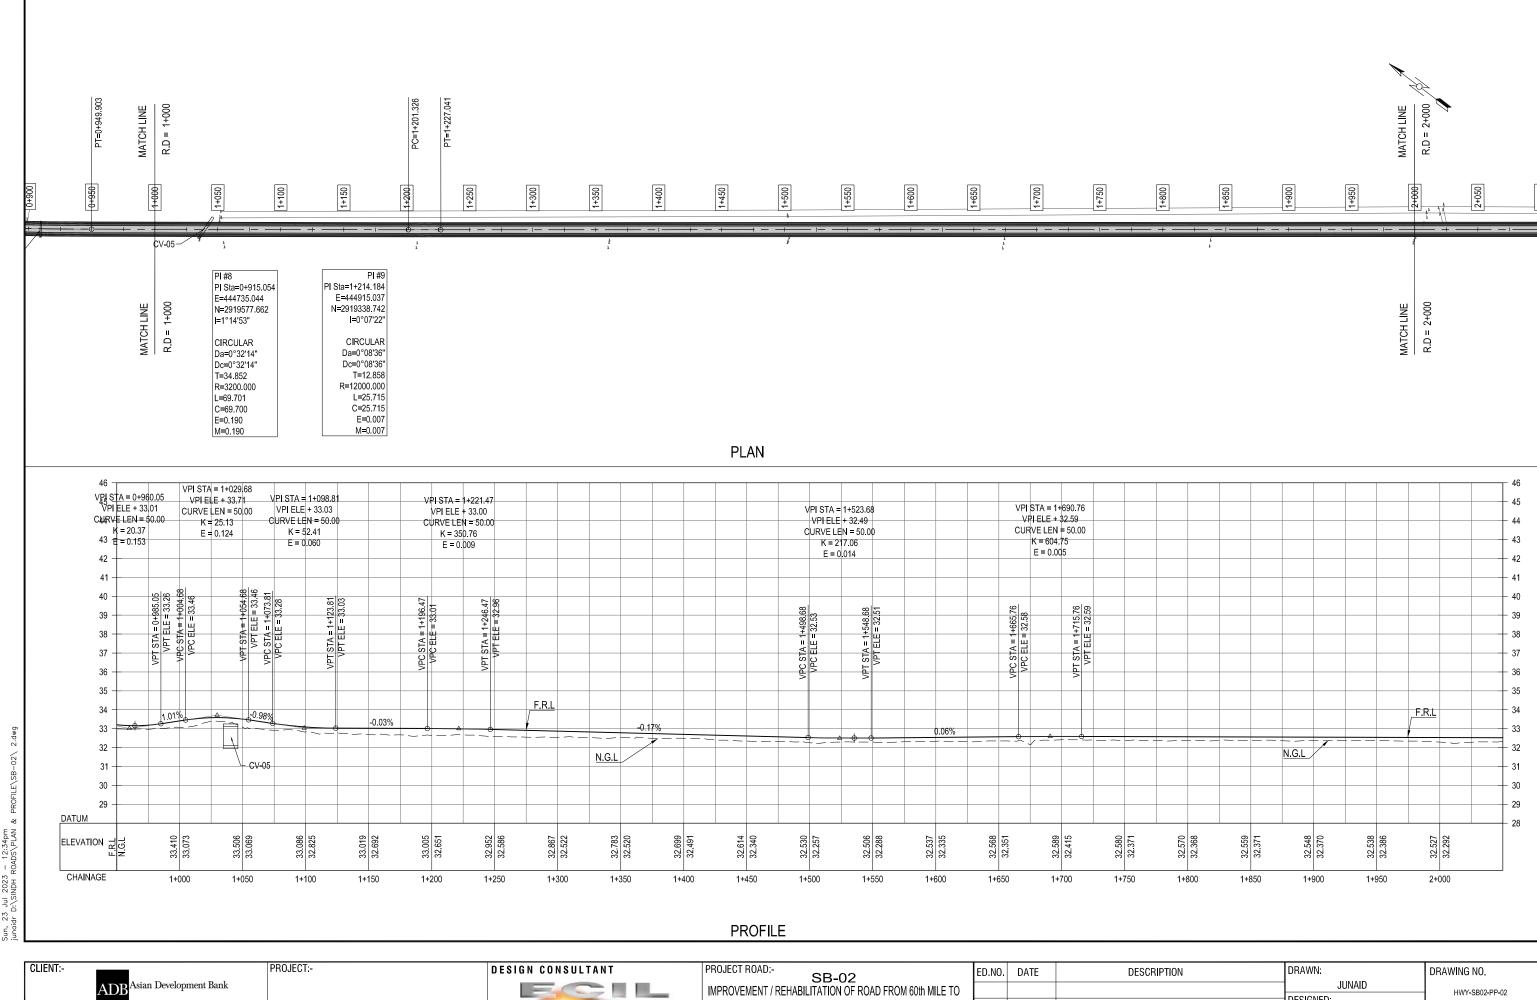

EXECUTING AGENCY:-WORKS AND SERVICES DEPARTMENT **GOVERNMENT OF SINDH**

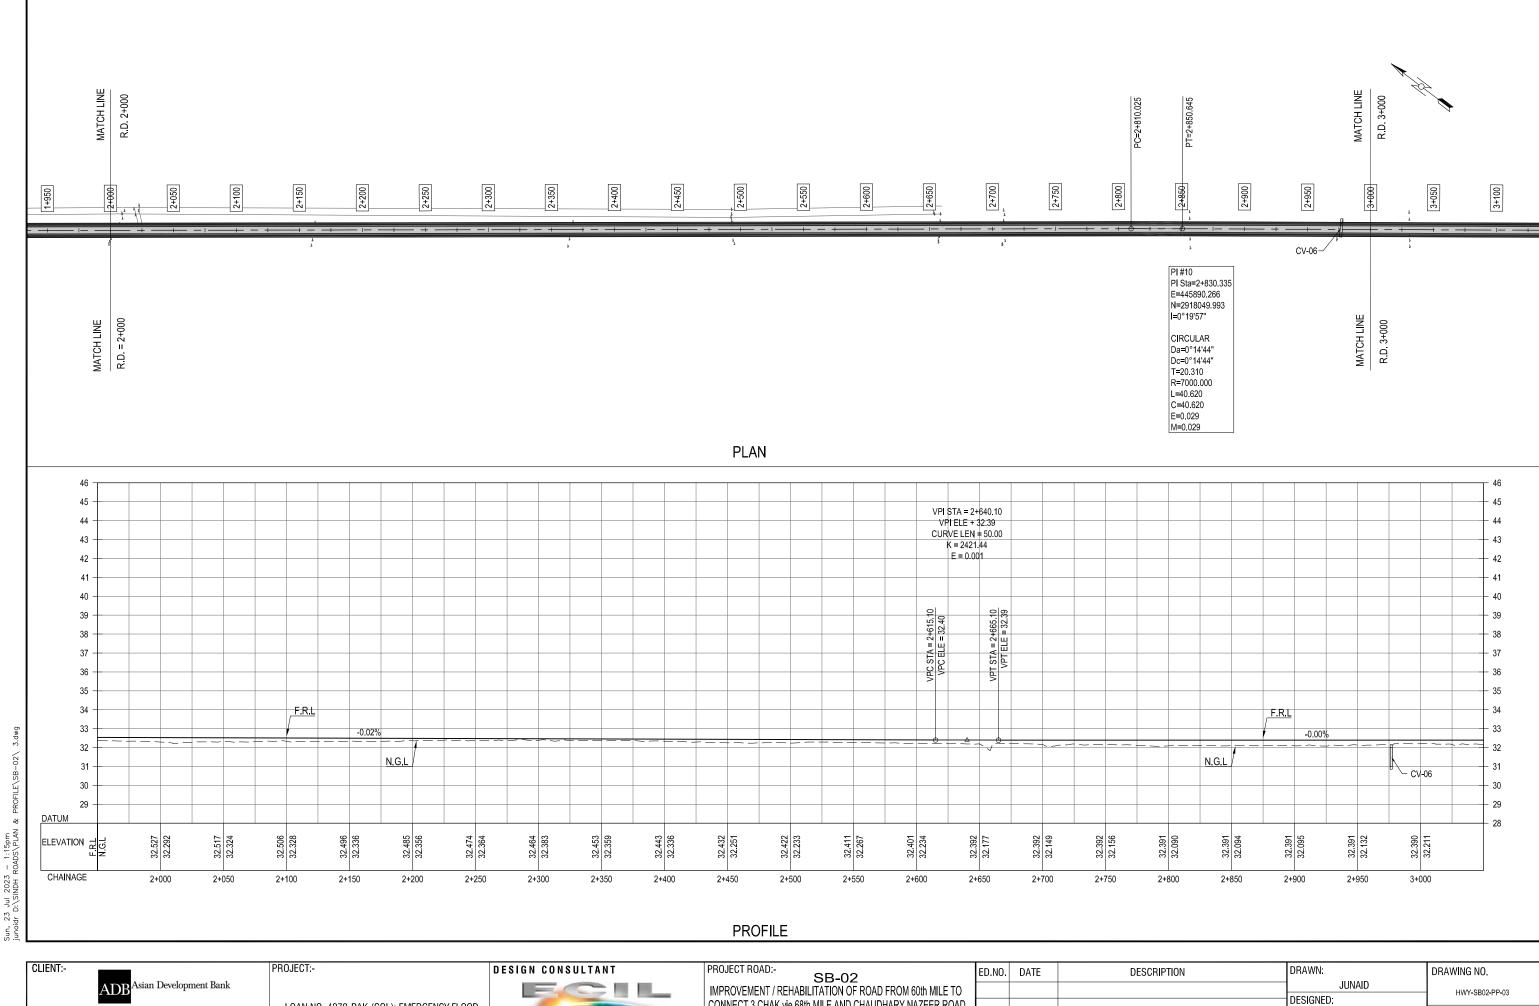LOAN NO. 4279-PAK (COL): EMERGENCY FLOOD ASSISTANCE PROJECT (EFAP)

In association with

	SB-0	02	
IMPROVEMENT	/ REHABILITATION	OF ROAD FROM	30th MILE TO
CONNECT 3 CHA	AK vie 68th MILE AN	ID CHAUDHARY N	AZEER ROAD
TITLE:-	PLAN & PRO	OFILE OF	

SB-02 CH: 2+000 TO 3+000

√ 60th MILE TO 🔠		
NAZEER ROAD		DESIGNED:
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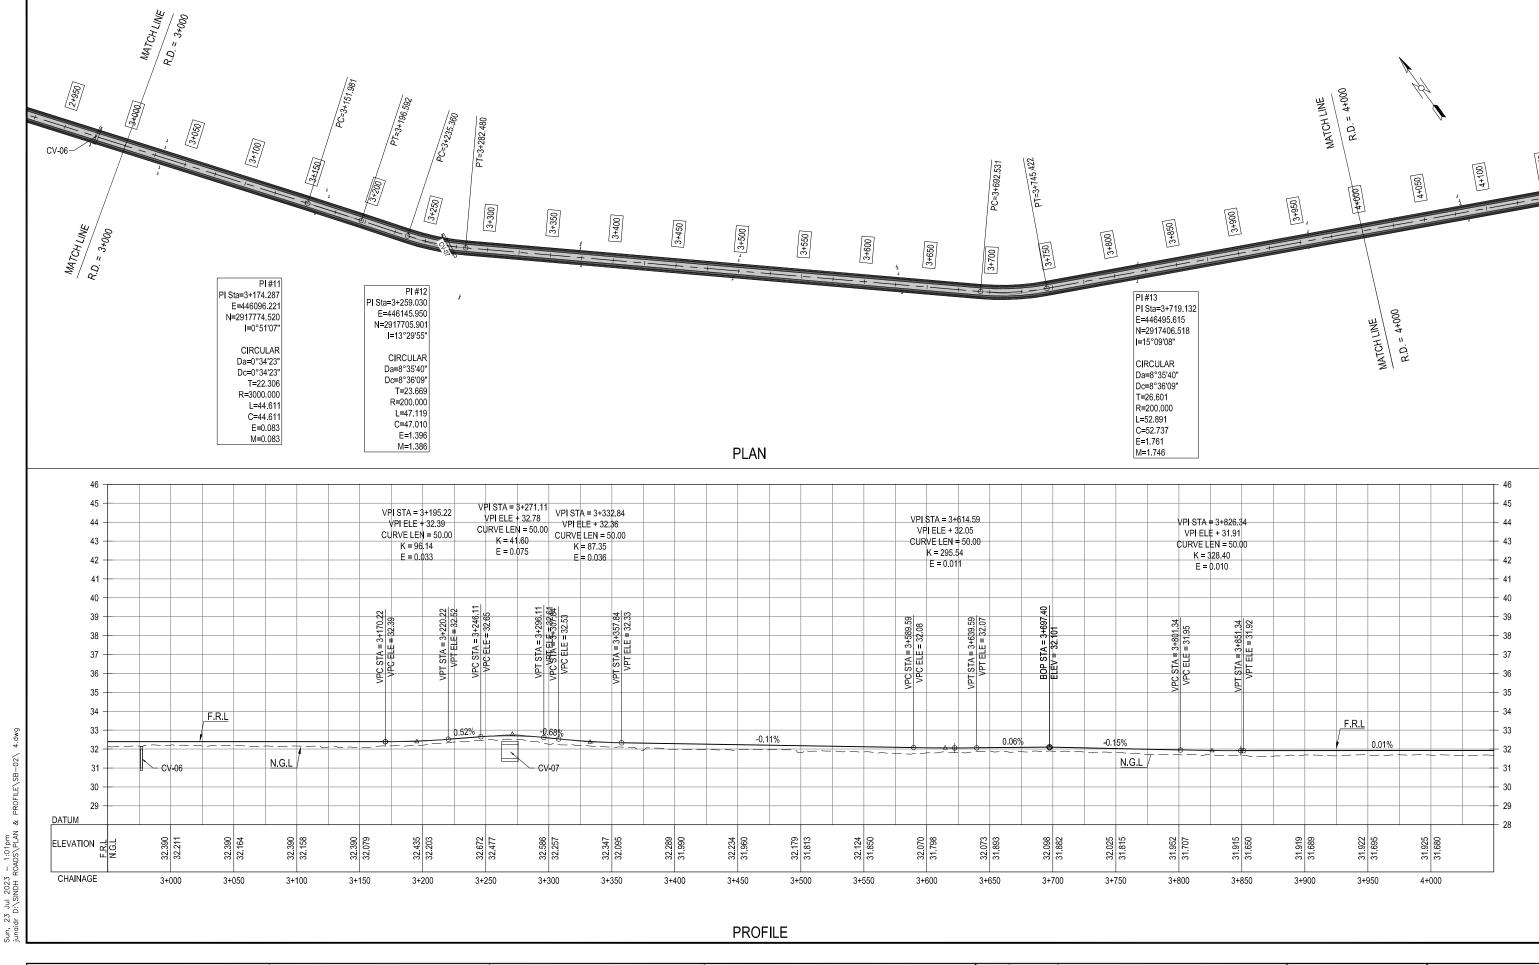
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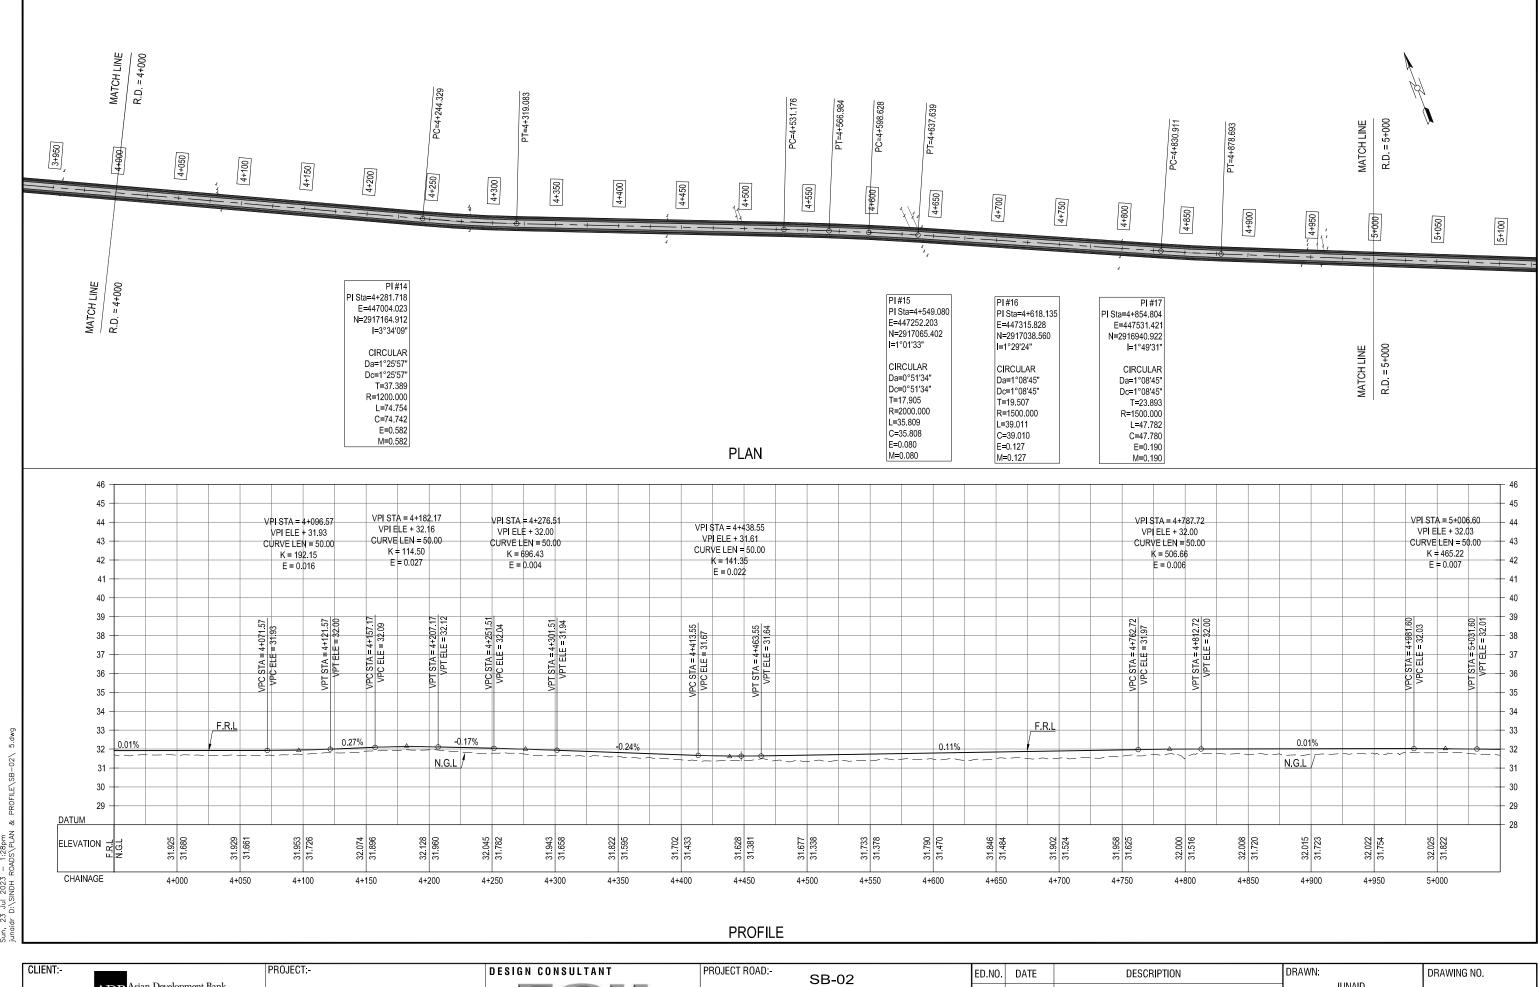
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JULY, 2023


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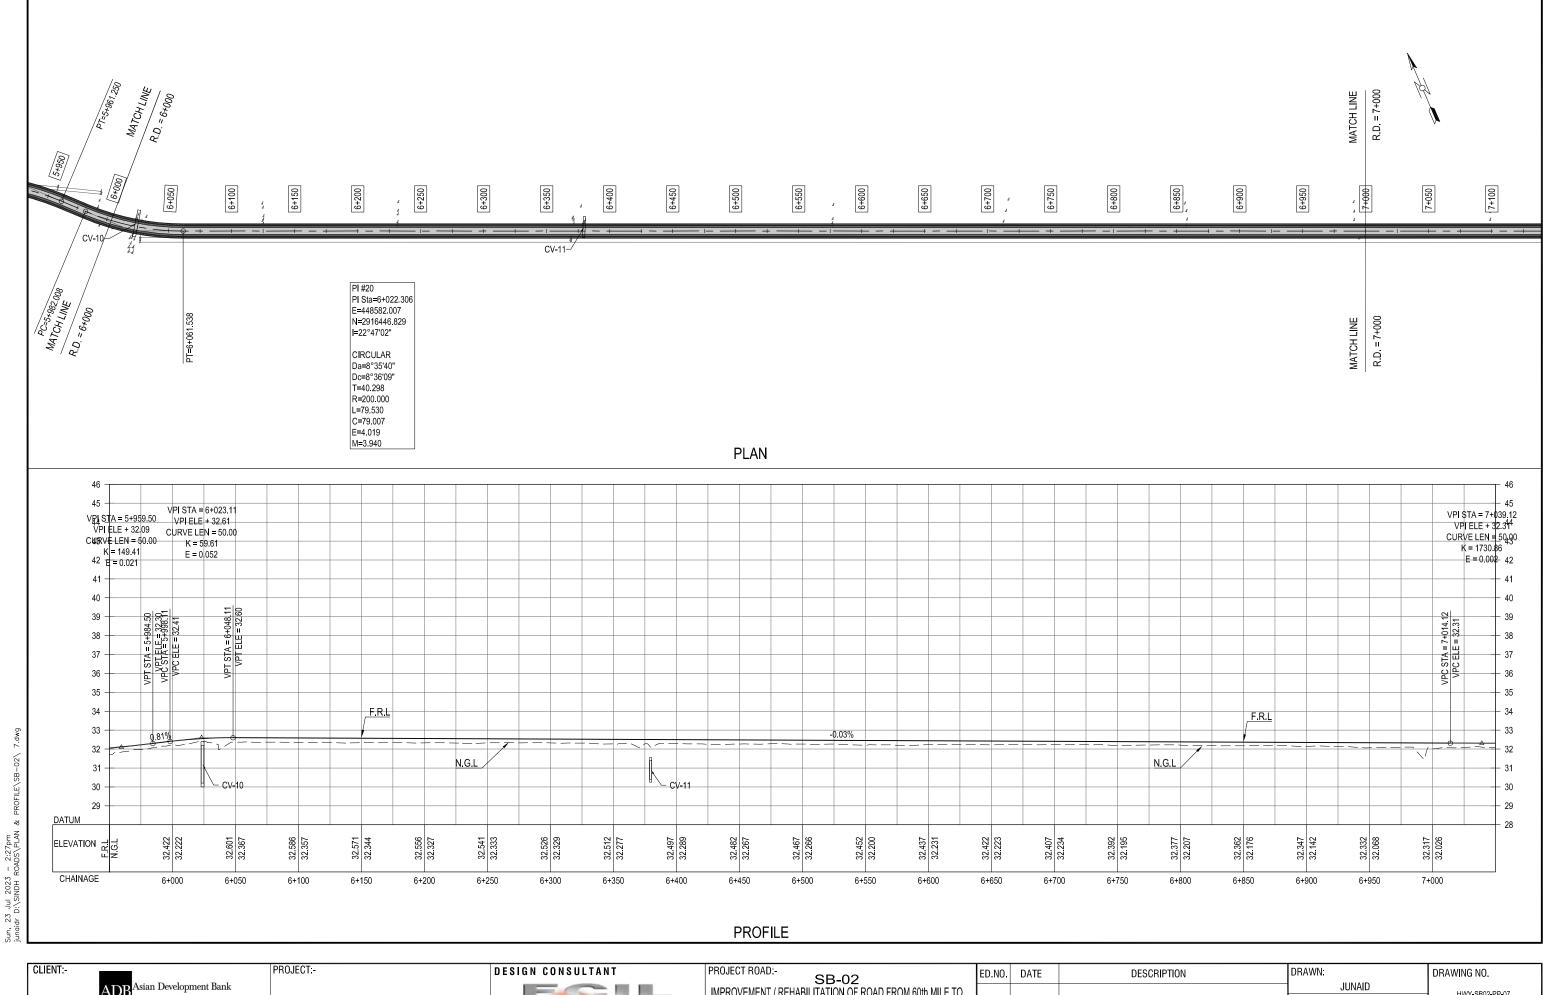





SB-02
IMPROVEMENT / REHABILITATION OF ROAD FROM 60th MILE TO sian Development Bank JUNAID HWY-SB02-PP-05 DESIGNED: CONNECT 3 CHAK vie 68th MILE AND CHAUDHARY NAZEER ROAD LOAN NO. 4279-PAK (COL): EMERGENCY FLOOD EXECUTING AGENCY: HINA ZEESHAN ASSISTANCE PROJECT (EFAP) H=1:2000 TITLE:-In association with WORKS AND SERVICES PLAN & PROFILE OF V=1:20 CHECKED: NAVEED HASSAN SB-02 CH: 4+000 TO 5+000 DEPARTMENT Edition. **GOVERNMENT OF SINDH** DATE: JULY, 2023



SB-02
IMPROVEMENT / REHABILITATION OF ROAD FROM 60th MILE TO sian Development Bank JUNAID HWY-SB02-PP-06 DESIGNED: CONNECT 3 CHAK vie 68th MILE AND CHAUDHARY NAZEER ROAD LOAN NO. 4279-PAK (COL): EMERGENCY FLOOD EXECUTING AGENCY: ASSISTANCE PROJECT (EFAP) H=1:2000 TITLE:-In association with WORKS AND SERVICES PLAN & PROFILE OF V=1:20 CHECKED: SB-02 CH: 5+000 TO 6+000 NAVEED HASSAN DEPARTMENT Edition. **GOVERNMENT OF SINDH** DATE: JULY, 2023

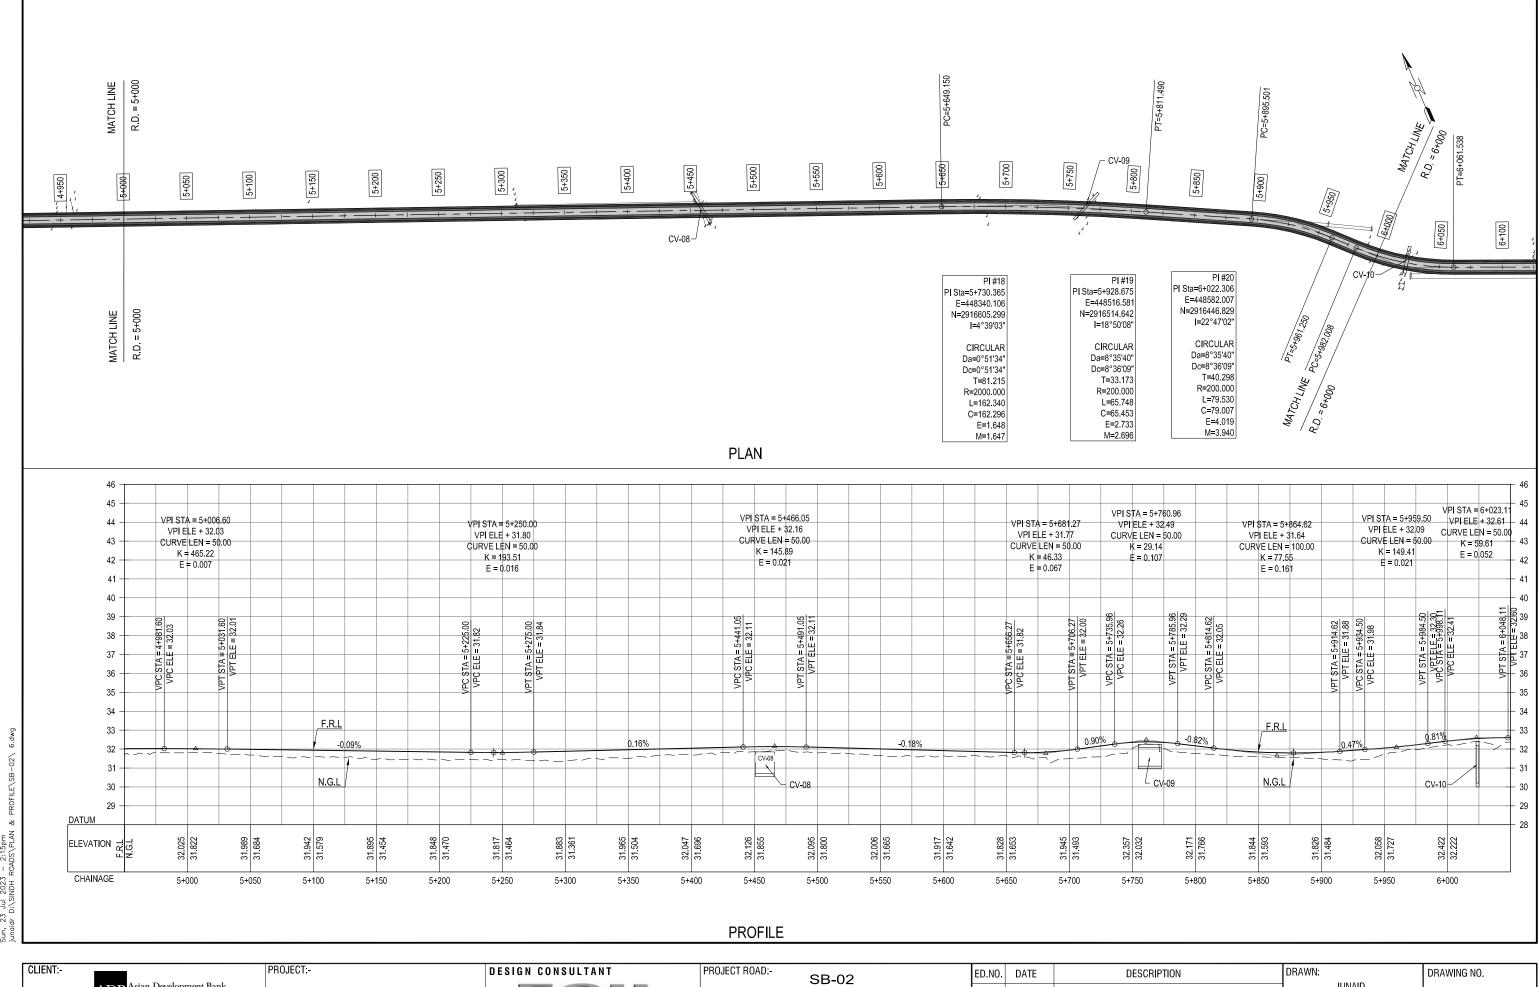

PROJECT ROAD:-SB-02 IMPROVEMENT / REHABILITATION OF ROAD FROM 60th MILE TO CONNECT 3 CHAK vie 68th MILE AND CHAUDHARY NAZEER ROAD HWY-SB02-PP-07 DESIGNED: LOAN NO. 4279-PAK (COL): EMERGENCY FLOOD EXECUTING AGENCY:-ASSISTANCE PROJECT (EFAP) TITLE:-H=1:2000 In association with WORKS AND SERVICES PLAN & PROFILE OF V=1:20 CHECKED: NAVEED HASSAN SB-02 CH: 6+000 TO 7+000 DEPARTMENT Edition. **GOVERNMENT OF SINDH** DATE: JULY, 2023

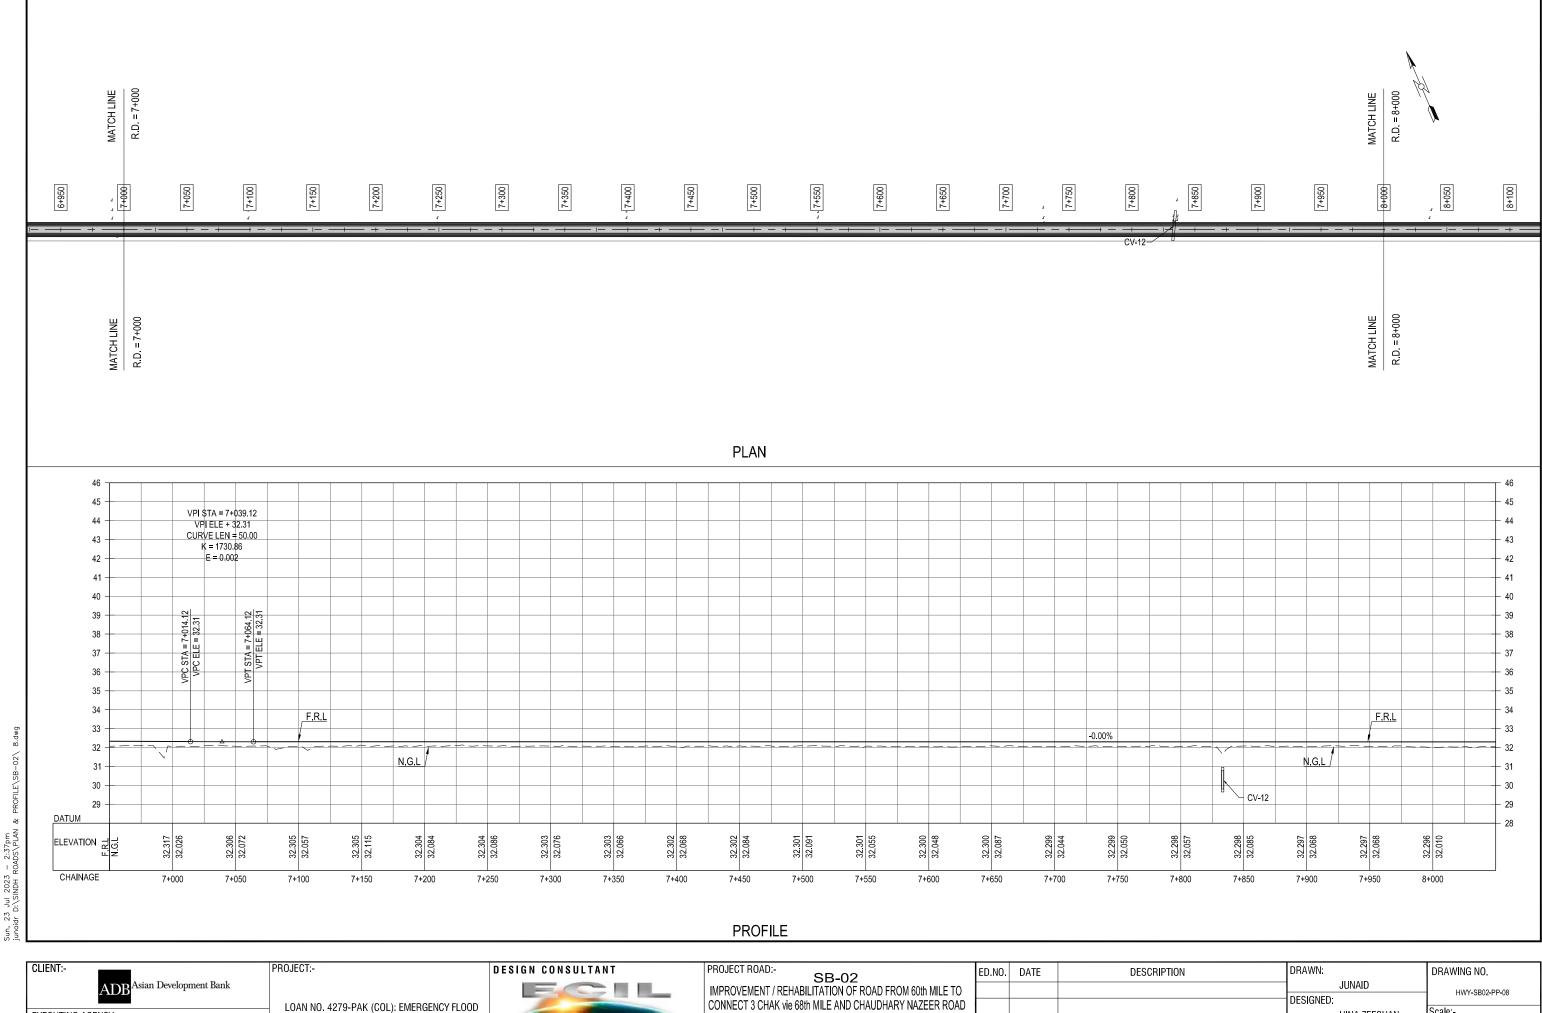

EXECUTING AGENCY:- \(\nabla \)

WORKS AND SERVICES DEPARTMENT **GOVERNMENT OF SINDH** ASSISTANCE PROJECT (EFAP)




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IMPROVEMENT / F	REHABILITATION (OF ROAD FROM 60	th MILE TO
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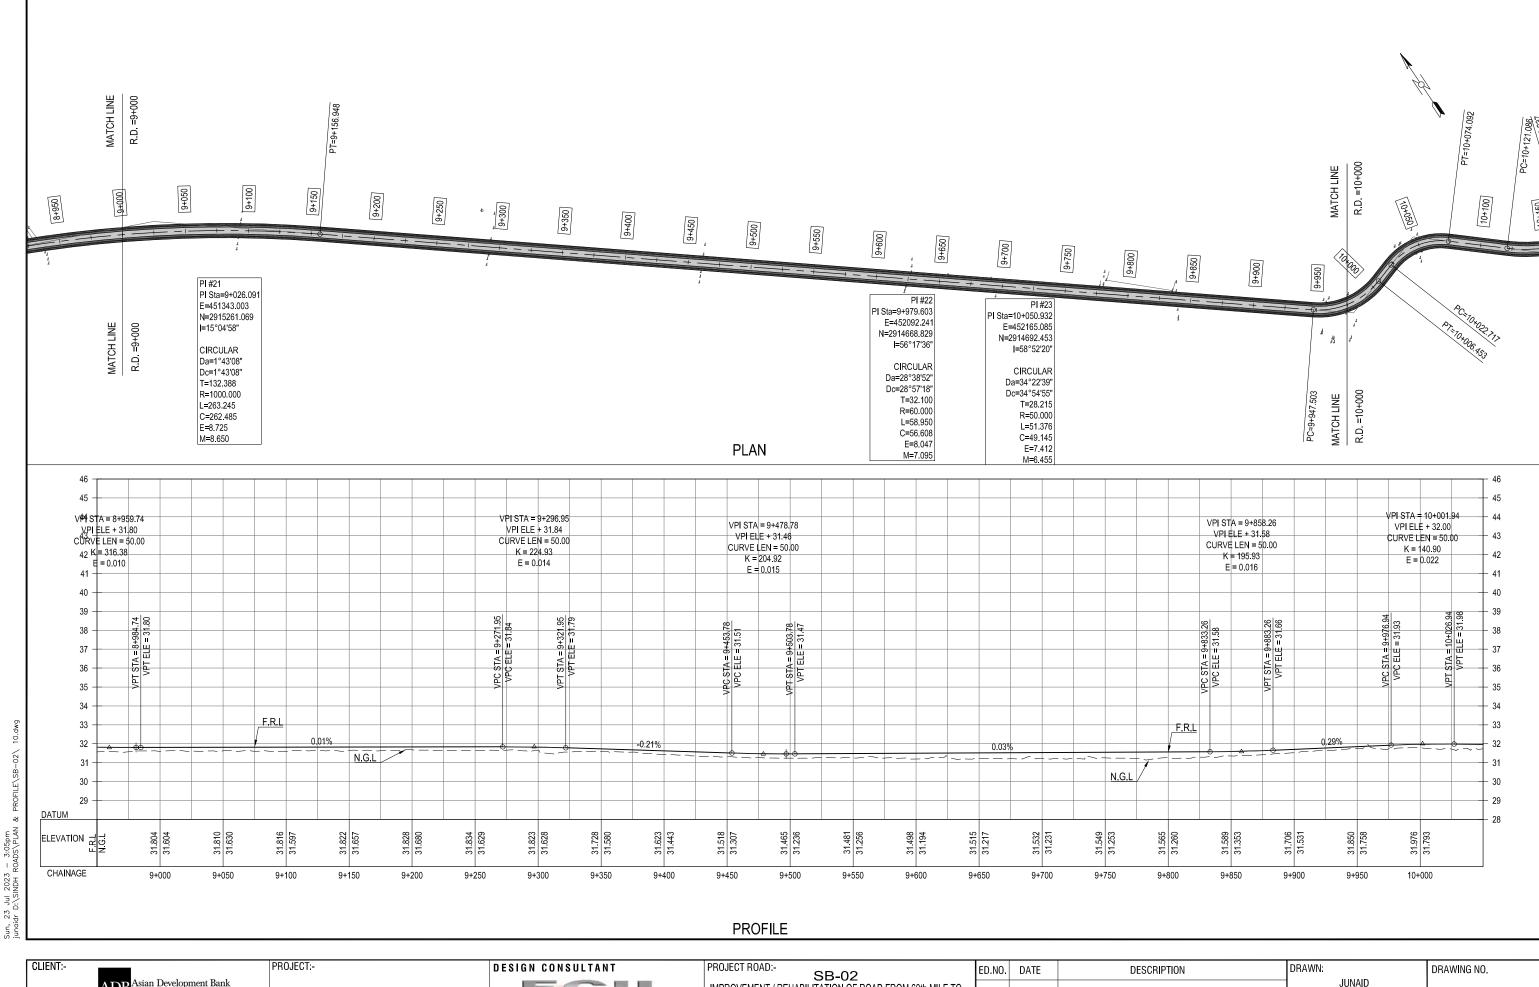
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SB-02
IMPROVEMENT / REHABILITATION OF ROAD FROM 60th MILE TO sian Development Bank JUNAID HWY-SB02-PP-09 DESIGNED: CONNECT 3 CHAK vie 68th MILE AND CHAUDHARY NAZEER ROAD LOAN NO. 4279-PAK (COL): EMERGENCY FLOOD EXECUTING AGENCY:-ASSISTANCE PROJECT (EFAP) H=1:2000 TITLE:-In association with WORKS AND SERVICES PLAN & PROFILE OF V=1:20 CHECKED: NAVEED HASSAN SB-02 CH: 8+000 TO 9+000 DEPARTMENT Edition. **GOVERNMENT OF SINDH** DATE: JULY, 2023



ADB Asian Development Bank

EXECUTING AGENCY:
WORKS AND SERVICES

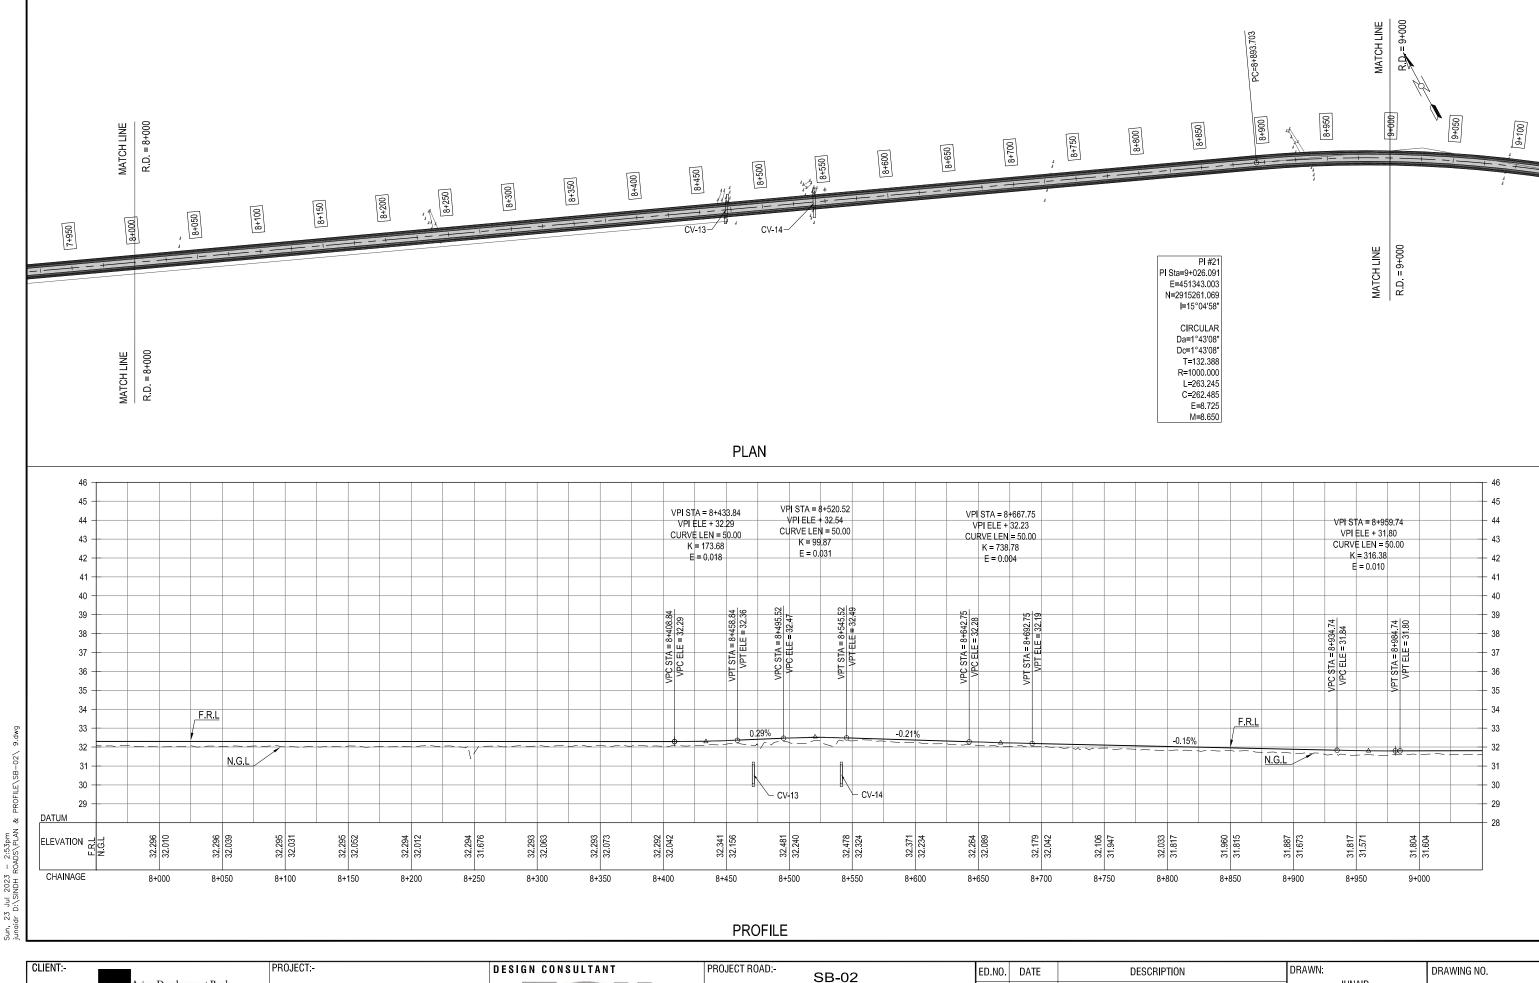DEPARTMENT

GOVERNMENT OF SINDH

LOAN NO. 4279-PAK (COL): EMERGENCY FLOOD ASSISTANCE PROJECT (EFAP) In association with

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CONNECT 3	CHAK vie 68th MILE AND CHAUDHARY NAZEER R	OAD
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EXECUTING AGENCY:WORKS AND SERVICES
DEPARTMENT
GOVERNMENT OF SINDH

LOAN NO. 4279-PAK (COL): EMERGENCY FLOOD ASSISTANCE PROJECT (EFAP) In association with

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CONNECT 3 CI	IAK vie 68th MILE AND CHAUDHARY NAZEER ROAD
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CH: 10+000 TO 11+000

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EXECUTING AGENCY:WORKS AND SERVICES
DEPARTMENT
GOVERNMENT OF SINDH


LOAN NO. 4279-PAK (COL): EMERGENCY FLOOD
ASSISTANCE PROJECT (EFAP)
DEPARTMENT

In association with

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IMPROVEMENT	/ REHABILITATION	NOF ROAD FROM	60th MILE TO
CONNECT 3 CHA	AK vie 68th MILE A	ND CHAUDHARY I	NAZEER ROAD
TITLE:-	PLAN & PR	OFILE OF	

SB-02 CH: 11+000 TO 12+000

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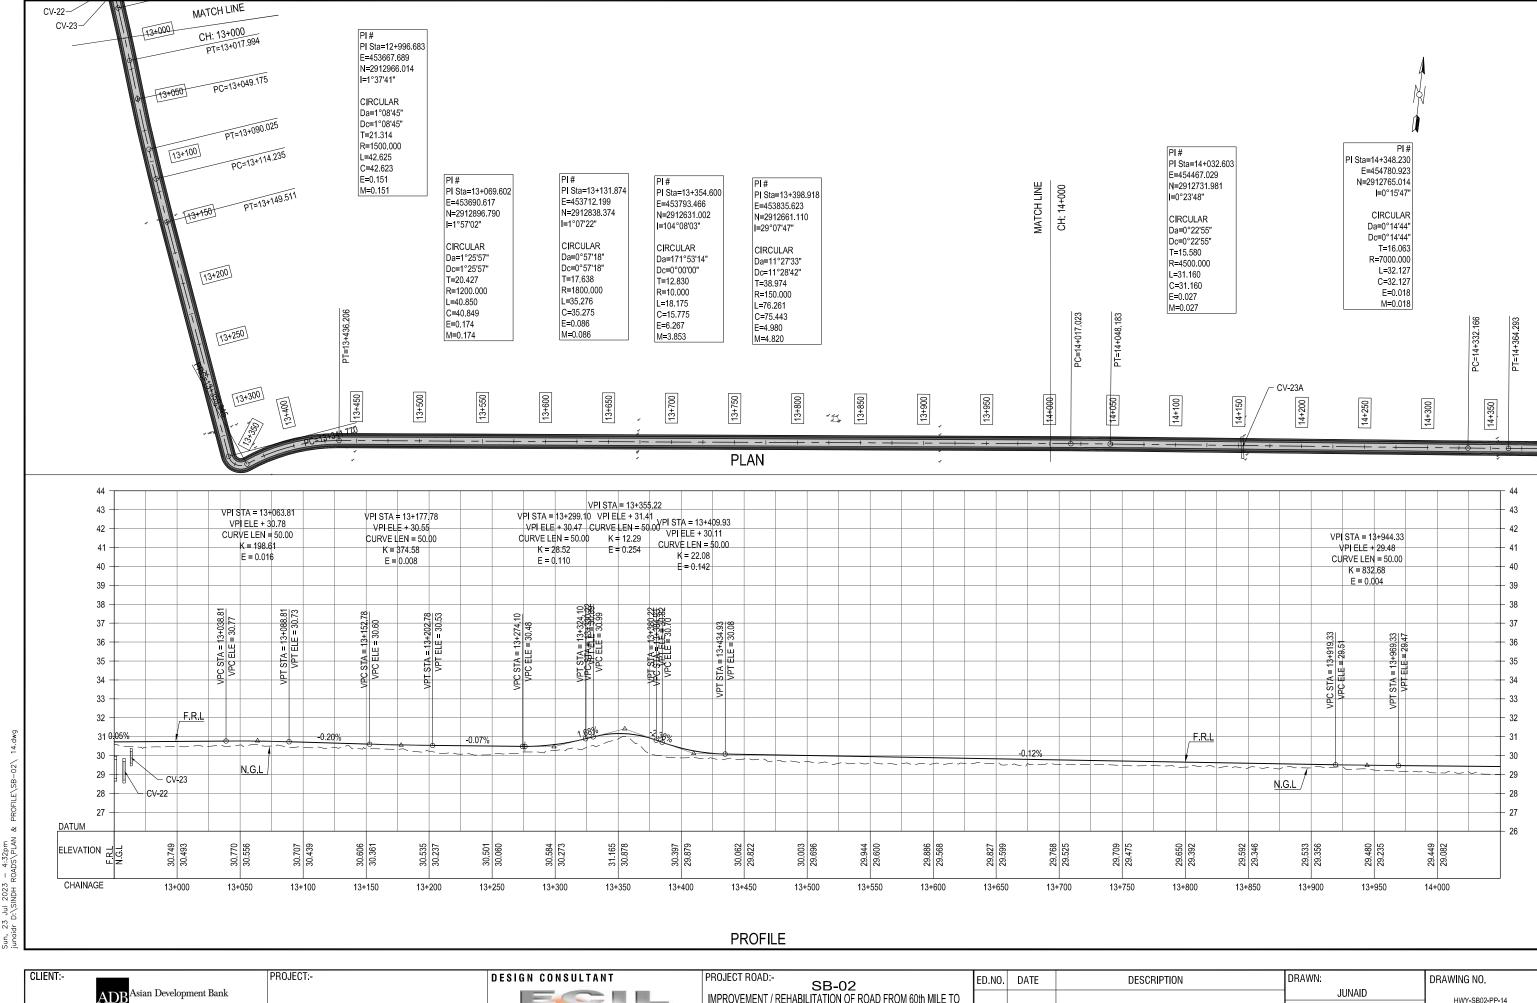
WORKS AND SERVICES
DEPARTMENT
GOVERNMENT OF SINDH

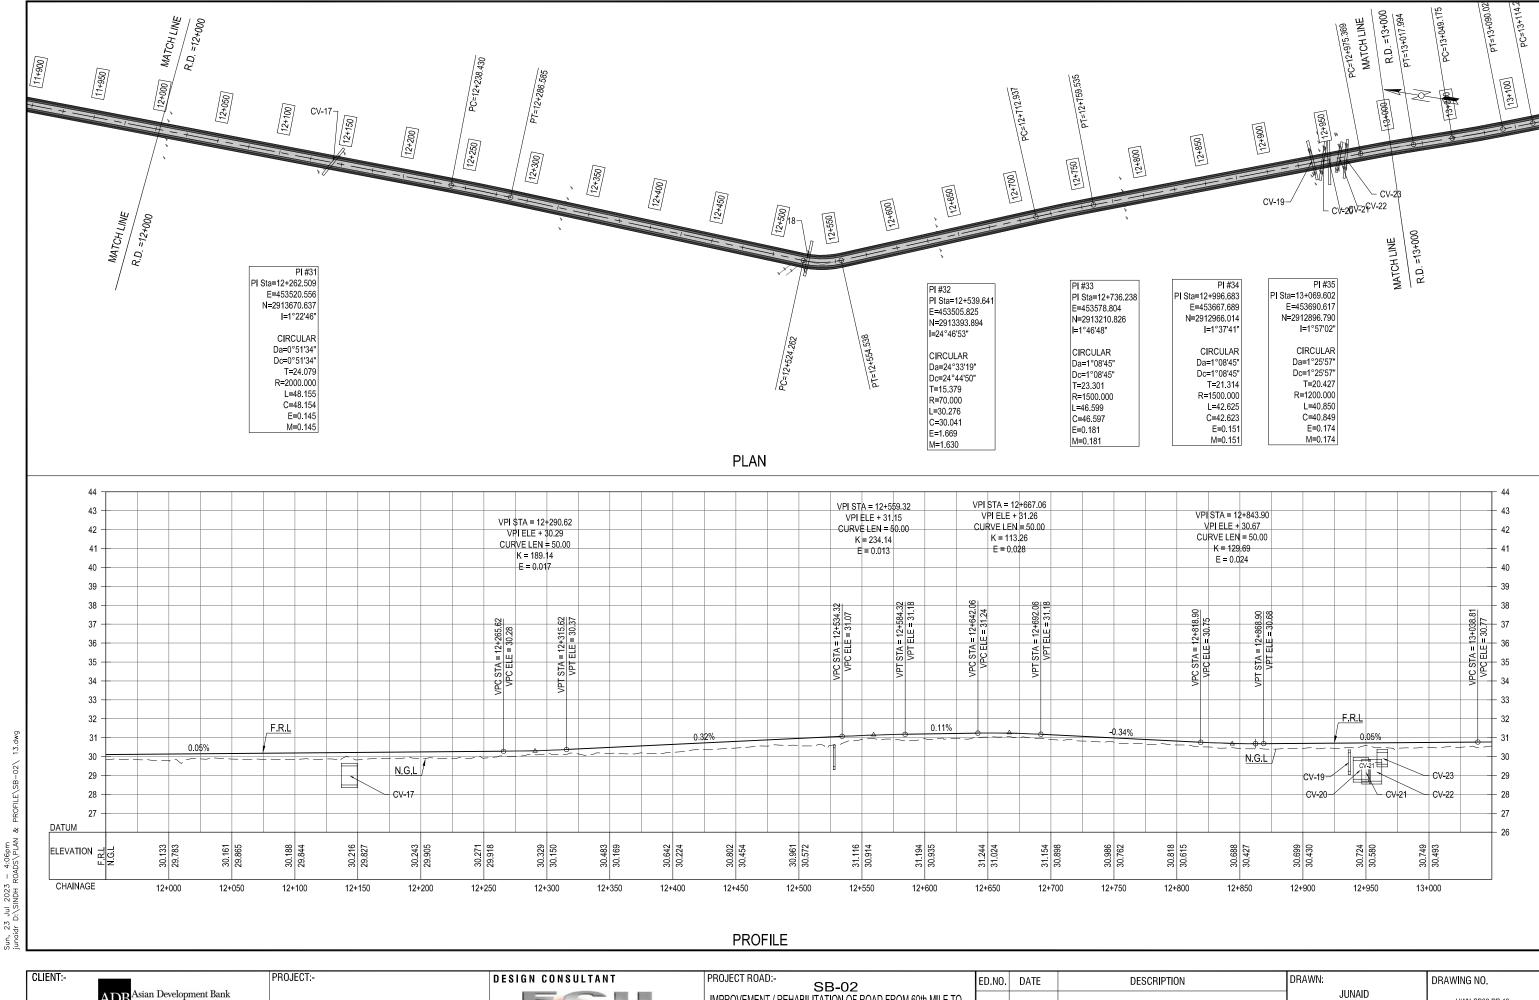LOAN NO. 4279-PAK (COL): EMERGENCY FLOOD ASSISTANCE PROJECT (EFAP) In association with

	SB-02
IMPROVEMENT	「/REHABILITATION OF ROAD FROM 60th MILE TO
CONNECT 3 CH	IAK vie 68th MILE AND CHAUDHARY NAZEER ROAD
TITLE:-	PLAN & PROFILE OF

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	CH: 12+000 TO 13+000

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WORKS AND SERVICES

DEPARTMENT

GOVERNMENT OF SINDH


LOAN NO. 4279-PAK (COL): EMERGENCY FLOOD
ASSISTANCE PROJECT (EFAP)

In association with

	SB-02
IMPROVEMENT	REHABILITATION OF ROAD FROM 60th MILE TO
CONNECT 3 CHA	K vie 68th MILE AND CHAUDHARY NAZEER ROAD
TITLE:-	PLAN & PROFILE OF

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	CH: 13+000 TO 14+000

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			DATE:	JULY, 2023	0

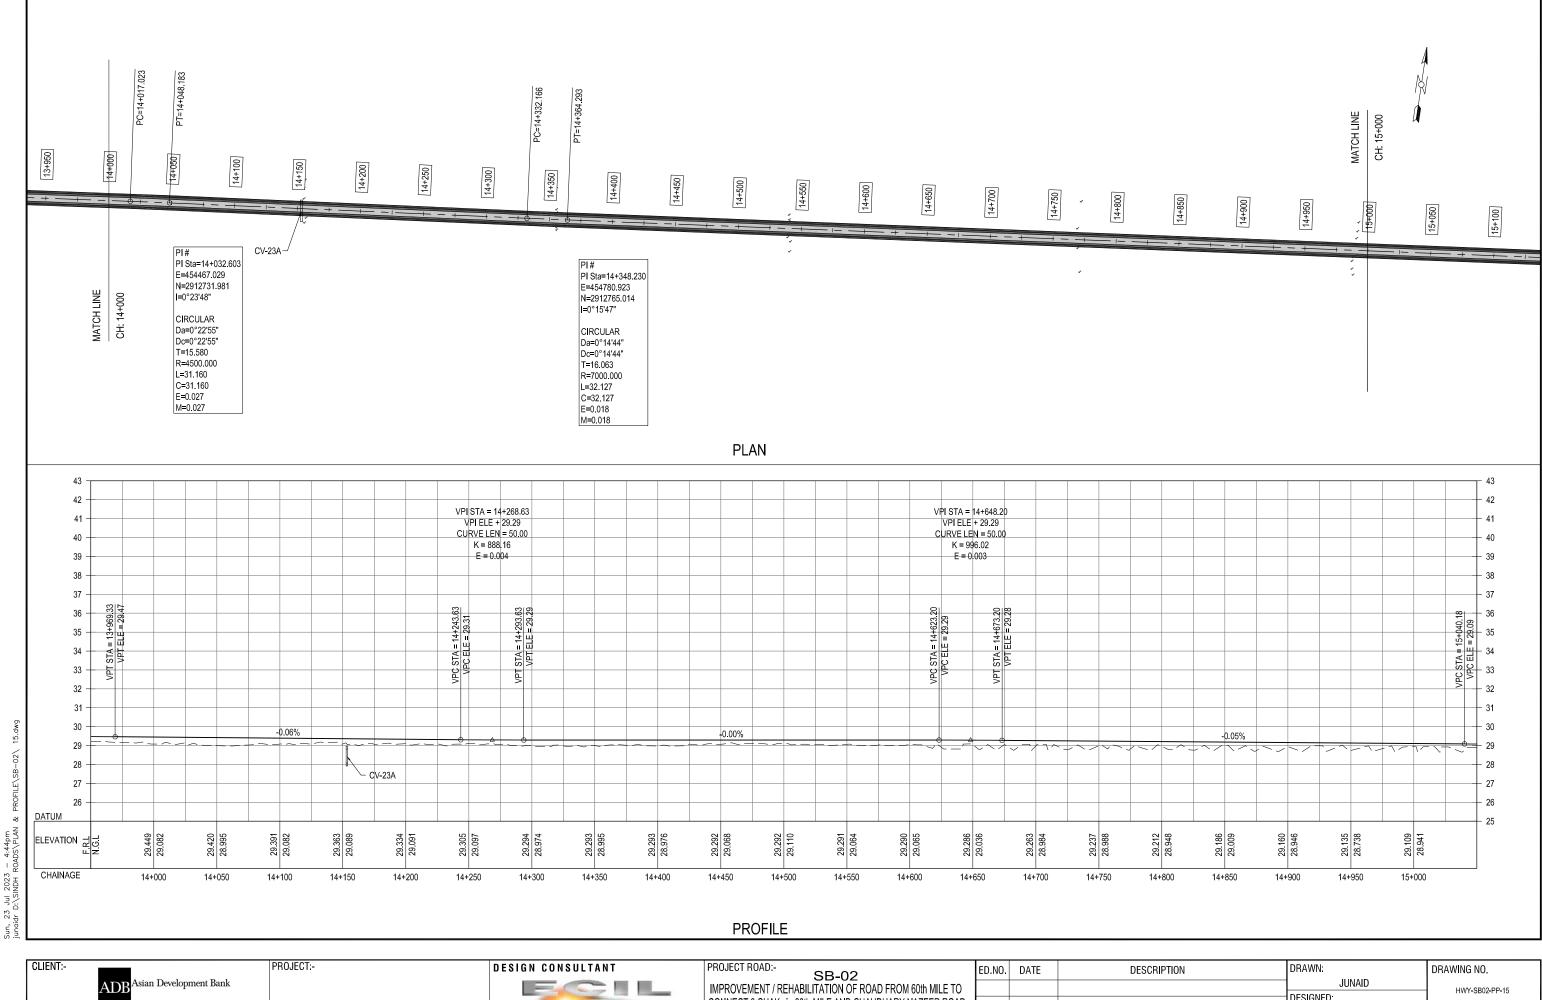

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WORKS AND SERVICES

DEPARTMENT

GOVERNMENT OF SINDH

LOAN NO. 4279-PAK (COL): EMERGENCY FLOOD ASSISTANCE PROJECT (EFAP) In association with


	SB-02
IMPROVEME	NT / REHABILITATION OF ROAD FROM 60th MILE TO
CONNECT 3 (CHAK vie 68th MILE AND CHAUDHARY NAZEER ROAD
TITLE:-	PLAN & PROFILE OF

SB-02 CH: 14+000 TO15+000

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JULY, 2023

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SB-02
IMPROVEMENT / REHABILITATION OF ROAD FROM 60th MILE TO ADB^{2} DESIGNED: CONNECT 3 CHAK vie 68th MILE AND CHAUDHARY NAZEER ROAD LOAN NO. 4279-PAK (COL): EMERGENCY FLOOD EXECUTING AGENCY:-ASSISTANCE PROJECT (EFAP) TITLE:-In association with WORKS AND SERVICES PLAN & PROFILE OF CHECKED: DEPARTMENT SB-02 CH: 15+000 TO 16+000 **GOVERNMENT OF SINDH** JULY,2023 ISSUED FOR APPROVAL DATE:

Asian Development Bank

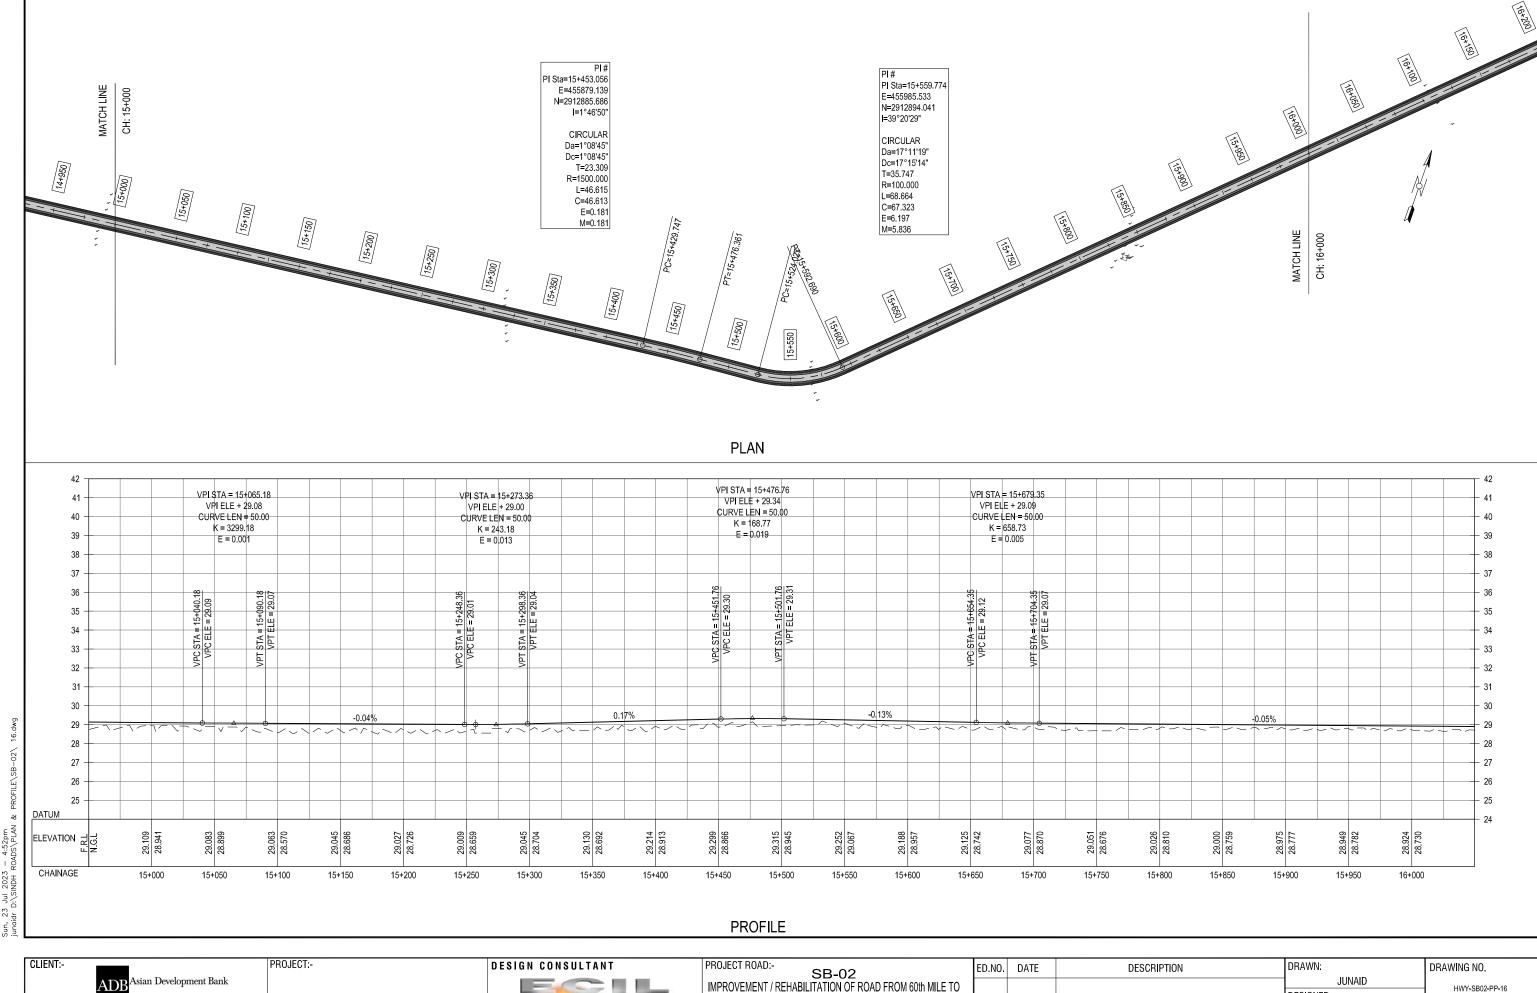GOVERNMENT OF SINDH

EXECUTING AGENCY:-WORKS AND SERVICES DEPARTMENT

LOAN NO. 4279-PAK (COL): EMERGENCY FLOOD ASSISTANCE PROJECT (EFAP)



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IMPROVEMENT / F	EHABILITATION (OF ROAD FROM	60th MILE TO
CONNECT 3 CHAK	vie 68th MILE AND	O CHAUDHARY I	NAZEER ROAD
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SB-02 CH: 16+000 TO 17+000

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Sun, 23 Jul 2023 — 4:47pm nsaqib D:\S SINDH ROAD\SB-2\ 18-SB-2-PP-18.dwg

ADB Asian Development Bank

EXECUTING AGENCY:

WORKS AND SERVICES

DEPARTMENT

LOAN NO. 4279-PAK (COL): EMERGENCY FLOOD

ASSISTANCE PROJECT (EFAP)

GOVERNMENT OF SINDH


In association with

SB-02
IMPROVEMENT / REHABILITATION OF ROAD FROM 60th MILE TO
CONNECT 3 CHAK vie 68th MILE AND CHAUDHARY NAZEER ROAD
TITLE:PLAN & PROFILE OF

SB-02 CH: 17+000 TO 18+000

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IMPROVEMENT / REHABILITATION OF ROAD FROM 60th MILE TO HWY-SB02-PP-19 DESIGNED: CONNECT 3 CHAK vie 68th MILE AND CHAUDHARY NAZEER ROAD LOAN NO. 4279-PAK (COL): EMERGENCY FLOOD Scale:-HINA ZEESHAN EXECUTING AGENCY:-H=1:3000 ASSISTANCE PROJECT (EFAP) TITLE:-In association with PLAN & PROFILE OF WORKS AND SERVICES CHECKED: NAVEED HASSAN SB-02 CH: 18+000 TO 19+000 Edition. DEPARTMENT **GOVERNMENT OF SINDH** JULY,2023 ISSUED FOR APPROVAL DATE: JULY, 2023

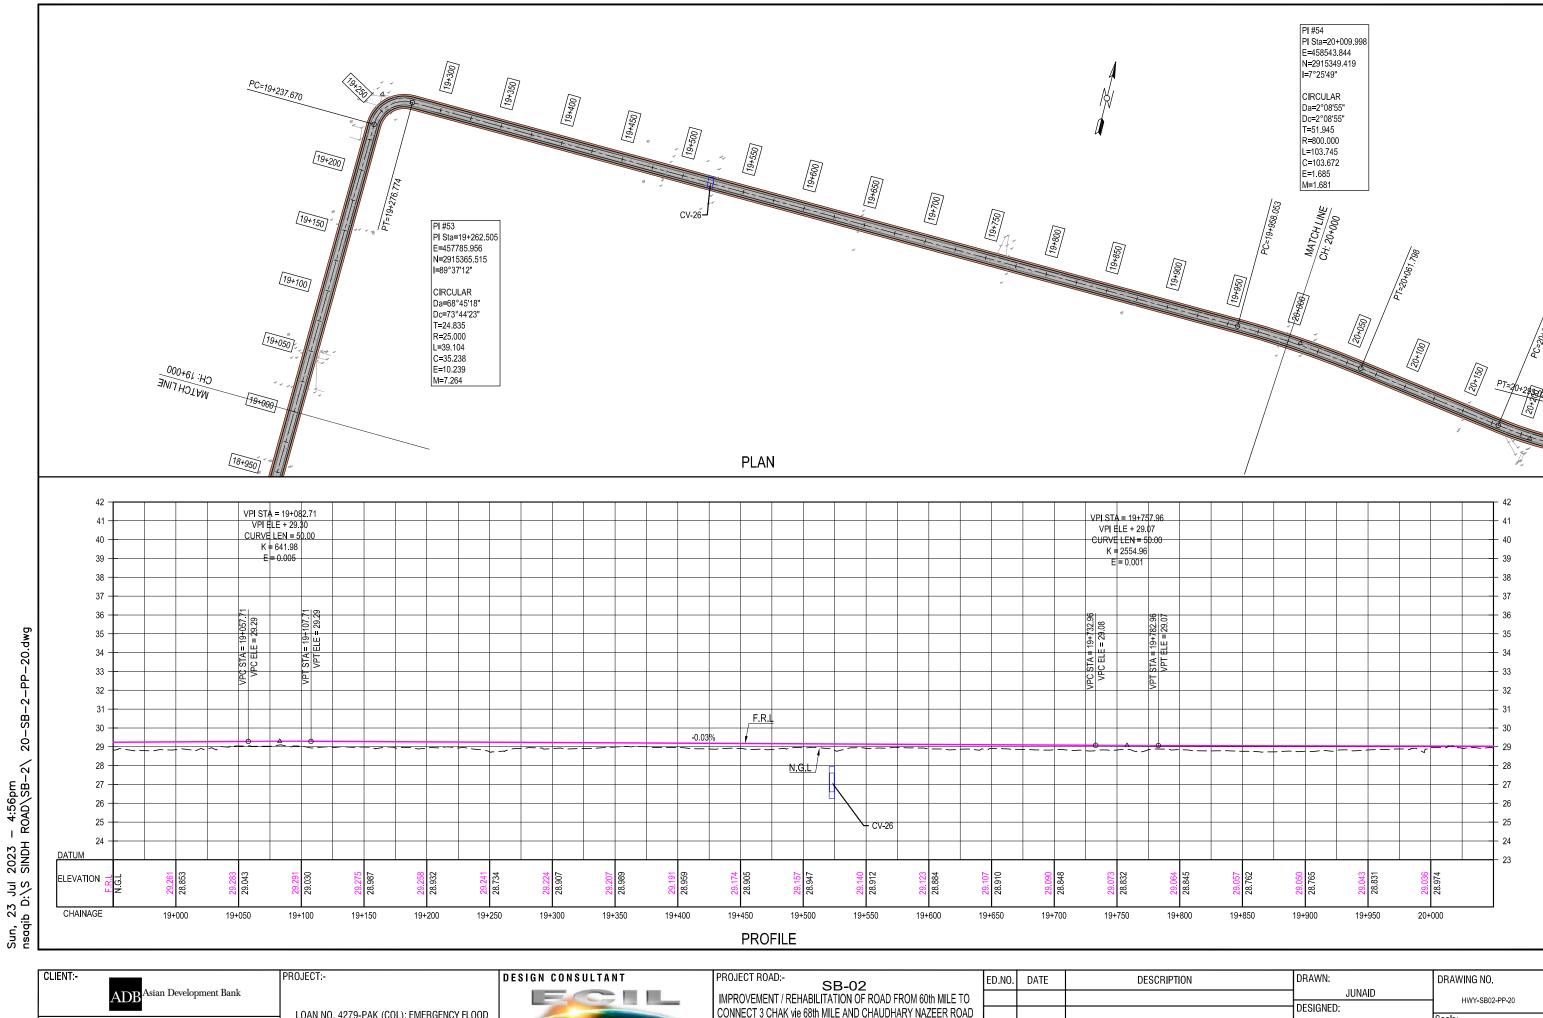

CONNECT 3 CHAK vie 68th MILE AND CHAUDHARY NAZEER ROAD LOAN NO. 4279-PAK (COL): EMERGENCY FLOOD HINA ZEESHAN EXECUTING AGENCY -H=1:3000 ASSISTANCE PROJECT (EFAP) TITLE:-In association with PLAN & PROFILE OF WORKS AND SERVICES CHECKED: NAVEED HASSAN SB-02 CH: 19+000 TO 20+000 DEPARTMENT Edition. GOVERNMENT OF SINDH JULY,2023 ISSUED FOR APPROVAL DATE: JULY, 2023

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EXECUTING AGENCY:WORKS AND SERVICES
DEPARTMENT
GOVERNMENT OF SINDH

Asian Development Bank


LOAN NO. 4279-PAK (COL): EMERGENCY FLOOD ASSISTANCE PROJECT (EFAP)



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IMPROVEMENT / F	EHABILITATION OF ROAD FROM 60th MILE TO
CONNECT 3 CHAK	vie 68th MILE AND CHAUDHARY NAZEER ROAD
TTLE:-	PLAN & PROFILE OF

SB-02 CH: 20+000 TO 21+000

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WORKS AND SERVICES DEPARTMENT GOVERNMENT OF SINDH ASSISTANCE PROJECT (EFAP)

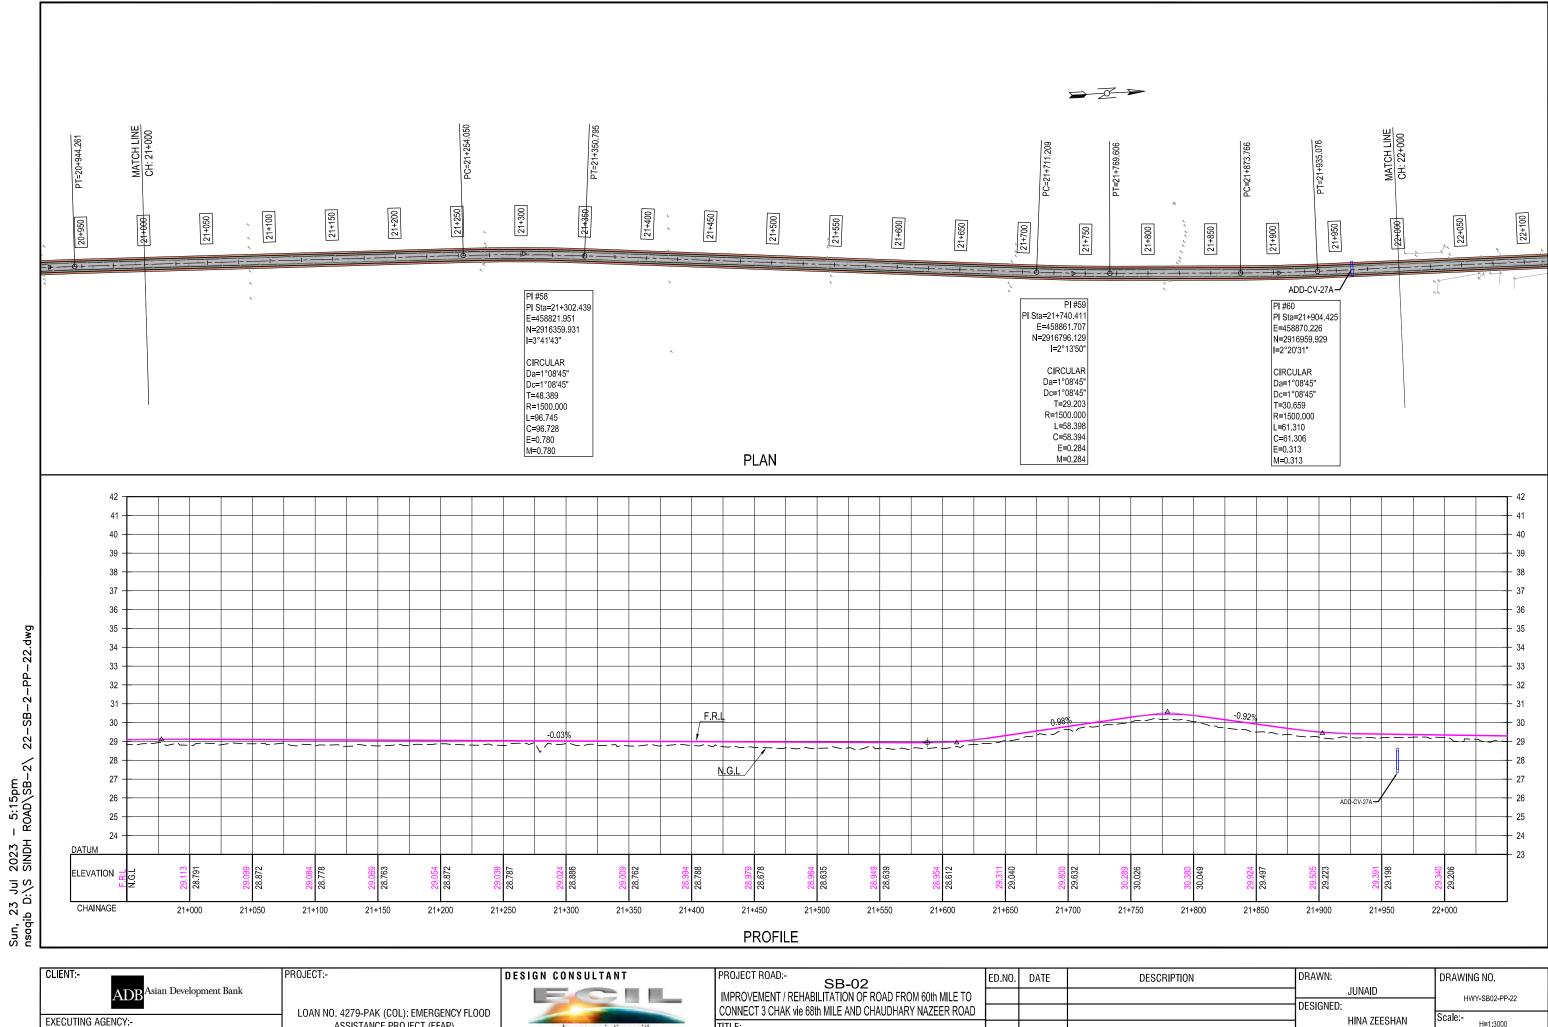

	SB-C)2	
IMPROVEMENT / F	REHABILITATION	OF ROAD FROM	60th MILE TO
CONNECT 3 CHAK	vie 68th MILE ANI	D CHAUDHARY N	NAZEER ROAD
TTLE:-	PLAN & PRC	FILE OF	

SB-02 CH: 21+000 TO 22+000

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EXECUTING AGENCY:-

WORKS AND SERVICES DEPARTMENT **GOVERNMENT OF SINDH** ASSISTANCE PROJECT (EFAP)

In association with

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IMPROVEMENT / F	EHABILITATION OF ROAD FROM 60th MILE TO
CONNECT 3 CHAK	vie 68th MILE AND CHAUDHARY NAZEER ROAD
TITLE:-	PLAN & PROFILE OF

SB-02 CH: 22+000 TO 23+000

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Scale:-HINA ZEESHAN H=1:3000 CHECKED: NAVEED HASSAN Edition. DATE: JULY, 2023

2023 - 5:25pm SINDH ROAD\SB-2\ Sun, 23 Jul 3 nsaqib D:\S


> DESIGNED: CONNECT 3 CHAK vie 68th MILE AND CHAUDHARY NAZEER ROAD LOAN NO. 4279-PAK (COL): EMERGENCY FLOOD HINA ZEESHAN EXECUTING AGENCY:-H=1:3000 ASSISTANCE PROJECT (EFAP) TITLE:-In association with PLAN & PROFILE OF WORKS AND SERVICES CHECKED: NAVEED HASSAN SB-02 CH: 23+000 TO 24+000 Edition. DEPARTMENT **GOVERNMENT OF SINDH** JULY,2023 ISSUED FOR APPROVAL DATE: JULY, 2023




DESIGNED: CONNECT 3 CHAK vie 68th MILE AND CHAUDHARY NAZEER ROAD LOAN NO. 4279-PAK (COL): EMERGENCY FLOOD Scale:-HINA ZEESHAN EXECUTING AGENCY:-H=1:3000 ASSISTANCE PROJECT (EFAP) TITLE:-In association with PLAN & PROFILE OF WORKS AND SERVICES CHECKED: NAVEED HASSAN SB-02 CH: 24+000 TO 25+000 Edition. DEPARTMENT **GOVERNMENT OF SINDH** JULY,2023 ISSUED FOR APPROVAL DATE: JULY, 2023

2023 - 5:32pm SINDH ROAD\SB-2\ Sun, 23 Jul Snsaqib D:\S

> CONNECT 3 CHAK vie 68th MILE AND CHAUDHARY NAZEER ROAD LOAN NO. 4279-PAK (COL): EMERGENCY FLOOD HINA ZEESHAN EXECUTING AGENCY:-H=1:3000 ASSISTANCE PROJECT (EFAP) TITLE:-In association with PLAN & PROFILE OF WORKS AND SERVICES CHECKED: NAVEED HASSAN SB-02 CH: 25+000 TO 26+000 DEPARTMENT Edition. **GOVERNMENT OF SINDH** JULY,2023 ISSUED FOR APPROVAL DATE: JULY, 2023

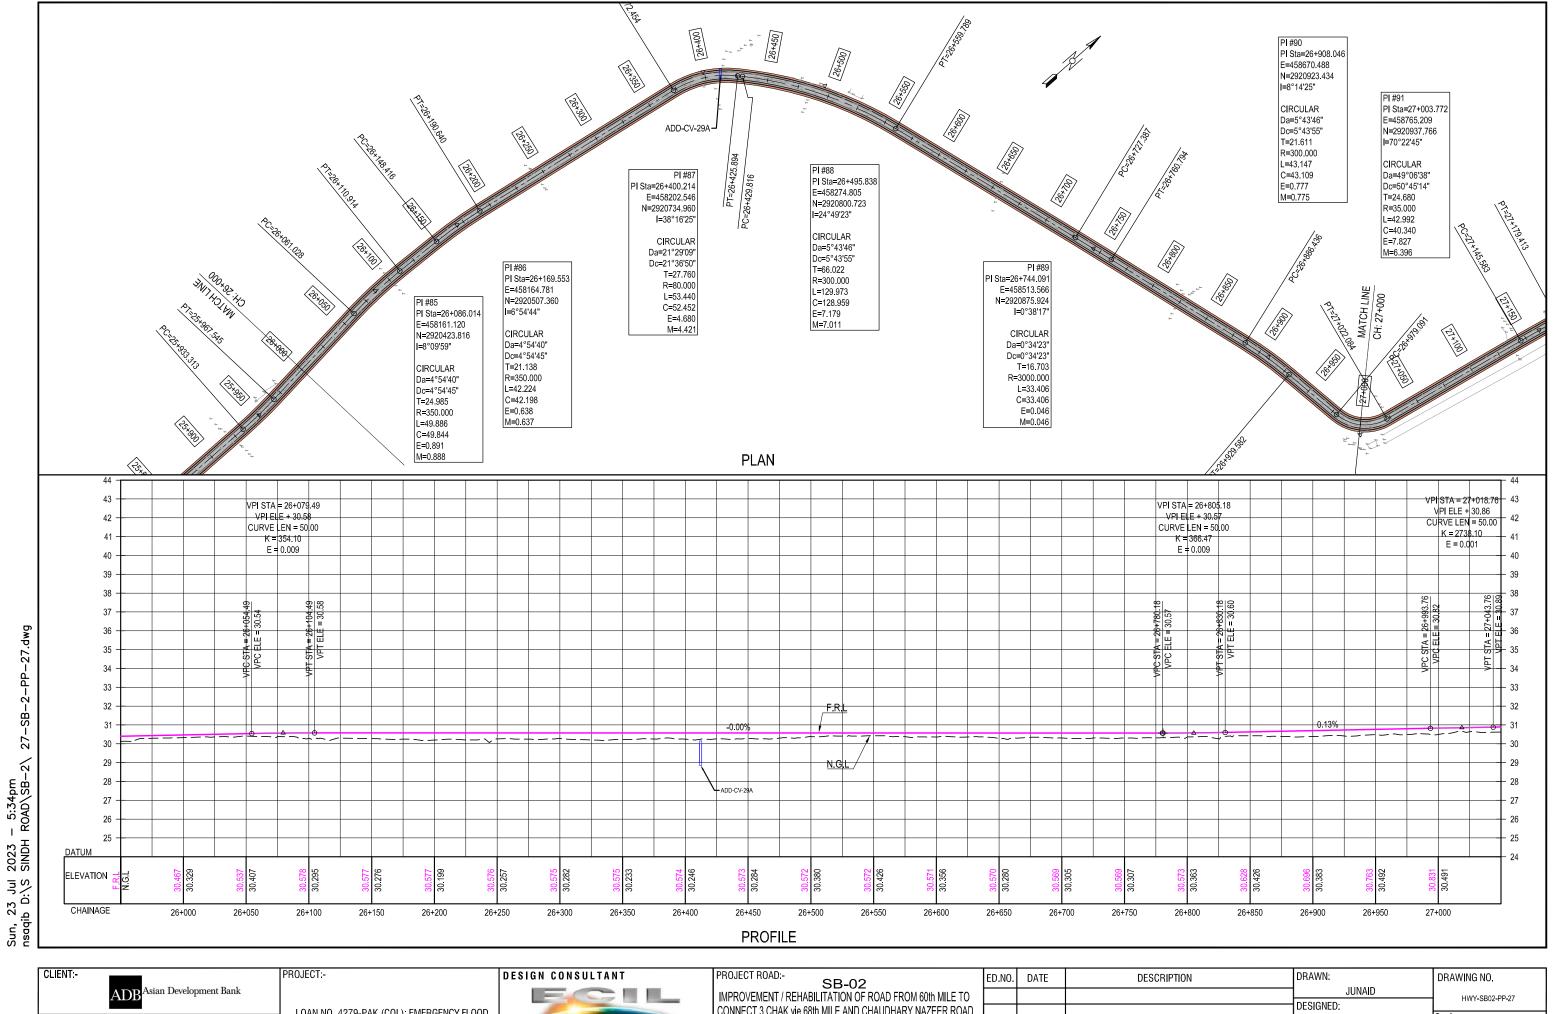

CONNECT 3 CHAK vie 68th MILE AND CHAUDHARY NAZEER ROAD LOAN NO. 4279-PAK (COL): EMERGENCY FLOOD Scale:-HINA ZEESHAN EXECUTING AGENCY:-H=1:3000 ASSISTANCE PROJECT (EFAP) TITLE:-In association with PLAN & PROFILE OF WORKS AND SERVICES CHECKED: NAVEED HASSAN SB-02 CH: 26+000 TO 27+000 DEPARTMENT Edition. **GOVERNMENT OF SINDH** JULY,2023 ISSUED FOR APPROVAL DATE: JULY, 2023

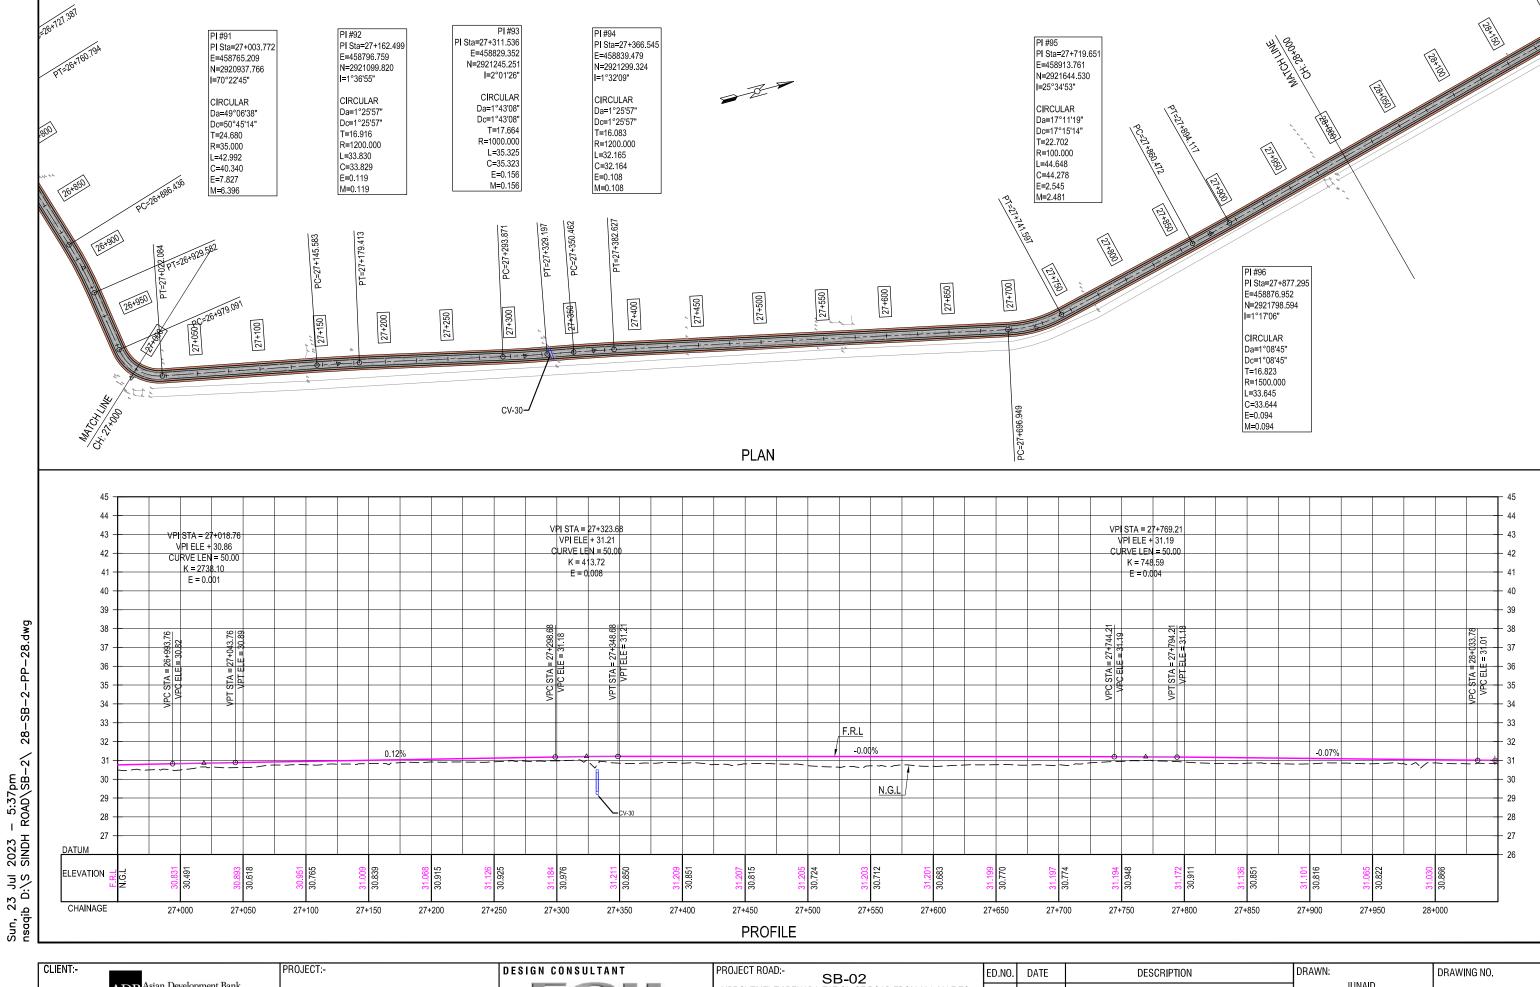



EXECUTING AGENCY:-GOVERNMENT OF SINDH

DEPARTMENT

ASSISTANCE PROJECT (EFAP) WORKS AND SERVICES

In association with


CONNECT 3 CHAK vie 68th MILE AND CHAUDHARY NAZEER ROAD TITLE:-PLAN & PROFILE OF

SB-02 CH: 28+000 TO 29+000

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LOAN NO. 4279-PAK (COL): EMERGENCY FLOOD Scale:-HINA ZEESHAN EXECUTING AGENCY:-H=1:3000 ASSISTANCE PROJECT (EFAP) TITLE:-In association with PLAN & PROFILE OF WORKS AND SERVICES CHECKED: NAVEED HASSAN SB-02 CH: 29+000 TO 30+000 DEPARTMENT Edition. GOVERNMENT OF SINDH JULY,2023 ISSUED FOR APPROVAL DATE: JULY, 2023



DESIGNED: CONNECT 3 CHAK vie 68th MILE AND CHAUDHARY NAZEER ROAD LOAN NO. 4279-PAK (COL): EMERGENCY FLOOD HINA ZEESHAN EXECUTING AGENCY -H=1:3000 ASSISTANCE PROJECT (EFAP) TITLE:-In association with PLAN & PROFILE OF WORKS AND SERVICES CHECKED: NAVEED HASSAN SB-02 CH: 30+000 TO 31+000 DEPARTMENT Edition. GOVERNMENT OF SINDH JULY,2023 ISSUED FOR APPROVAL DATE: JULY, 2023

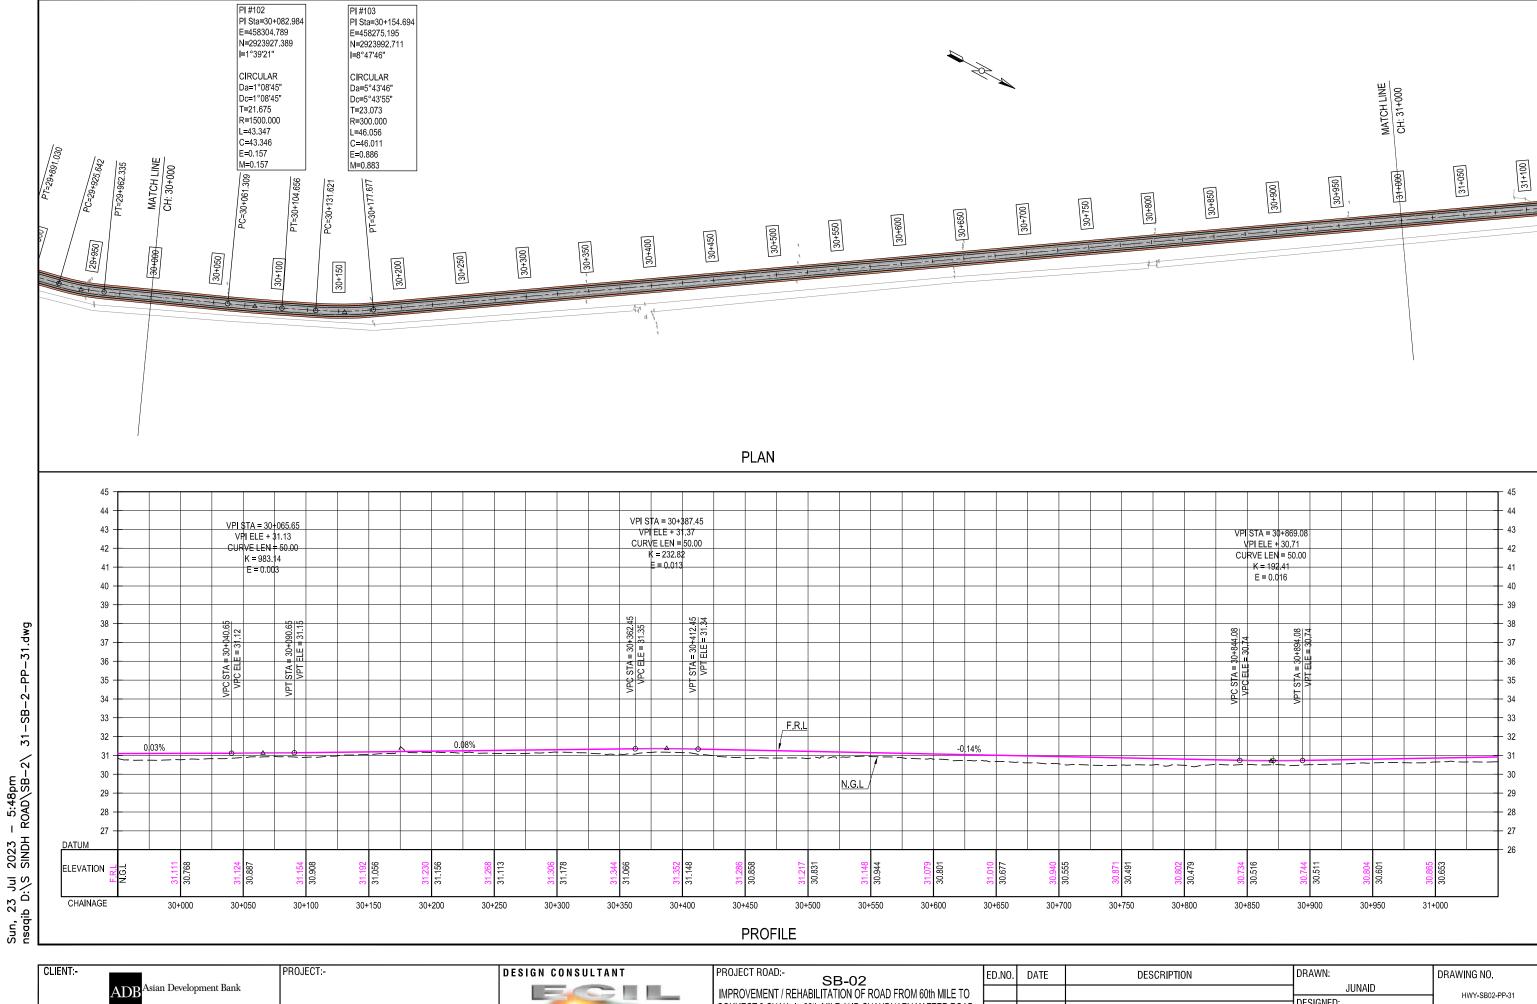EXECUTING AGENCY:-

/:-WORKS AND SERVICES DEPARTMENT GOVERNMENT OF SINDH LOAN NO. 4279-PAK (COL): EMERGENCY FLOOD ASSISTANCE PROJECT (EFAP)



	SB-02
IMPROVEM	ENT / REHABILITATION OF ROAD FROM 60th MILE TO
CONNECT 3	CHAK vie 68th MILE AND CHAUDHARY NAZEER ROAD
TITLE:-	PLAN & PROFILE OF
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	CH: 31+000 TO 31+903.252

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Scale:
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V=1:200

Edition.

LIST OF DRAWINGS

S. NO.	DESCRIPTION	DRAWING NO.
1	LIST OF DRAWING	2053-STR-SB02-LD-01
2	GENERAL NOTES	2053-STR-SB02-GN-01
	BRIDGE	
1	SCHEDULE OF BRIDGE	2053-STR-SB02-SCH-01
	PROPOSED NEW BRIDGE	
1	BRIDGE NO. B1 - GENERAL ARRANGEMENT	2053-STR-SB02-B1-101
2	BRIDGE NO. B1 - ABUTMENT	2053-STR-SB02-B1-102
3	BRIDGE NO. B1 - P.C. GIRDER	2053-STR-SB02-B1-103
4	BRIDGE NO. B1 - DECK SLAB AND DIAPHRAGMS	2053-STR-SB02-B1-104
5	BRIDGE NO. B1 - ABUTMENT	2053-STR-SB02-B1-201
6	BRIDGE NO. B1 - P.C. GIRDER	2053-STR-SB02-B1-202
7	BRIDGE NO. B1 - DECK SLAB	2053-STR-SB02-B1-203
8	BRIDGE NO. B1 - DIAPHRAGMS	2053-STR-SB02-B1-204
1	CULVERTS SCHEDULE OF CULVERTS	2053-STR-SB02-CU-SCH-01
1	SCHEDULE OF COLVERTS	2033-31K-3D02-CO-3CH-01
	BOX CULVERTS	
1	RCC BOX CULVERT - GENERAL ARRANGEMENT	2053-STR-SB02-BC-01
2	RCC BOX CULVERT - DETAILS OF APRON SLAB & WING WALLS	2053-STR-SB02-BC-02
3	RCC BOX CULVERT - REINFORCEMENT DETAILS OF BOX CULVERT	2053-STR-SB02-BC-03
4	RCC BOX CULVERT - REINFORCEMENT DETAILS OF APRON SLAB & WING WALLS (FOR CULVERT HEIGHT $\leqslant 2m$)	2053-STR-SB02-BC-04
5	REINFORCEMENT DETAILS OF APRON SLAB & WING WALLS FOR CULVERT HEIGHT > 2M	2053-STR-SB02-BC-05
	PIPE CULVERTS	
1	PIPE CULVERT - GENERAL ARRANGEMENT	2053-STR-SB02-PC-01
2	PIPE CULVERT - TYPICAL DETAILS WING WALL & APRON SLAB	2053-STR-SB02-PC-02
3	PIPE CULVERT - REINFORCEMENT DETAILS	2053-STR-SB02-PC-03

CLIENT:-	PROJECT:-	DESIGN CONSULTANT	PROJECT ROAD:- DISTRICT: BENAZIRABAD - SB-02	ED.NO.	DATE	DESCRIPTION	DRAWN:	F.A.S	DRAWING N	NO.
ADB ^{Asian} Development Bank	LOANING 4070 DAY (OOL), EMEDOENOVELOOD	ECIL	IMPROVEMENT / REHABILITATION OF ROAD FROM 60TH MILE TO CONNECT 3 CHAK VIA 68TH MILE AND CHAUDHARY NAZEER ROAD				DESIGNED:		2053-STI	R-SB02-LD-01
EXECUTING AGENCY:-	LOAN NO. 4279-PAK (COL): EMERGENCY FLOOD ASSISTANCE PROJECT (EFAP)	In association with	TITLE:-					R.I / M.A	Scale:-	1:1
WORKS AND SERVICES DEPARTMENT			LIST OF DRAWINGS				CHECKED:	S.A	Edition.	
GOVERNMENT OF SINDH							DATE:	JUNE 2023	i	

DATE:

JUNE 2023

GENERAL NOTES

- THE STRUCTURES ARE DESIGNED FOR CLASS AA AND CLASS A LOADING SPECIFIED IN GOVERNMENT OF WEST PAKISTAN, HIGHWAY DEPARTMENT CODE OF PRACTICE FOR HIGHWAY BRIDGES, 1967.
- CONCRETE IN ALL ELEMENTS OF SUBSTRUCTURE BELOW GROUND LINE TO BE MADE FROM ORDINARY PORTLAND CEMENT. IF SUBSOIL INVESTIGATIONS INDICATE THE PRESENCE OF SULPHATES IN BEARING SOIL, THEN SULPHATE RESISTING CEMENT INSTEAD OF ORDINARY PORTLAND CEMENT SHALL BE USED.
- ALL MATERIALS AND WORKMANSHIP SHALL CONFORM TO GENERAL SPECIFICATIONS (1998) AS 3. GIVEN IN CONTRACT DOCUMENTS AND RELEVANT AASHTO STANDARDS UNLESS OTHERWISE STIPULATED, WHEREVER ASTM SPECIFICATIONS ARE REFERRED TO, THEY SHALL BE FOLLOWED. A COPY OF THE STANDARDS SHALL BE SUPPLIED BY THE CONTRACTOR TO THE ENGINEER.
- DIMENSION ON THE DRAWINGS ARE IN MILLIMETER EXCEPT OTHERWISE NOTED.
- THE LOAD FACTORS AND LOAD COMBINATIONS ARE BASED ON THE STIPULATION GIVEN IN AASHTO LRFD BRIDGES DESIGN SPECIFICATIONS.
- ALL BLINDING CONCRETE SHALL BE LEAN CONCRETE.
- ALL STRUCTURAL CONCRETE SHALL CONFORM TO AASHTO T-22, AASHTO T-23 AND AASHTO T-24 AS SPECIFIED. MINIMUM COMPRESSIVE STRENGTHS AS MEASURED ON CYLINDERS AT 28 DAYS SHALL BE AS FOLLOWS.
 - CLASS A1 (210 kg./sq. cm.) FOR BARRIER, APPROACH SLAB AND ALL OTHER REINFORCED CONCRETE MEMBERS EXCEPT NOTED BELOW.
 - CLASS A3 (280 kg./sq. cm.) FOR TRANSOMS, PILECAPS, ABUTMENTS & RETAINING WALLS, PILES, PIER SHAFTS, DECK SLAB, DIAPHRAGMS & CULVERTS
 - CLASS D2 (425 kg./sq. cm.) FOR PRECAST PRESTRESSED CONCRETE GIRDERS.
- REINFORCING STEEL INDICATED ON DRAWINGS AS & SHALL BE AS PER AASHTO M31 GRADE 60
- ALL BAR DIAMETERS ARE IN MILLIMETERS. BARS ARE DESIGNATED BY A CODE CONSISTING OF THREE NUMBERS SEPARATED BY TWO HYPHENS, THE FIRST NUMBER IS THE BAR IDENTIFICATION MARK, THE MIDDLE NUMBER IS ITS DIAMETER IN MILLIMETERS AND THIRD NUMBER IS THE NUMBER OF BARS REQUIRED, FOR EXAMPLE

DIAMETER IN MILLIMETER NUMBERS REQUIRED BAR MARKS

- THE CONTRACTOR SHALL PREPARE ALL BAR BENDING SCHEDULES FTC. AND SUBMIT THEM FOR APPROVAL OF THE ENGINEER PRIOR TO CUTTING, BENDING AND PLACEMENT.
- ALL REINFORCING STEEL SHALL BE ACCURATELY LOCATED IN THE FORMWORK AND HELD FIRMLY IN PLACE, BEFORE PLACING OF CONCRETE BY MEANS OF 16 GUAGE BLACK ANNEALED WIRE AND ADEQUATELY DESIGNED SPACERS.
- UNLESS OTHERWISE SHOWN ON THE DRAWING LAPS IN REINFORCING STEEL BARS SHALL BE STAGGERED MINIMUM LENGTH OF LAP SHALL BE AS PER AASHTO REQUIREMENTS.
- 13. THE GIRDERS SHALL BE PLACED IN SPANS BY APPROVED MEANS TO ENSURE THEIR PLACEMENT WITHOUT DAMAGE AND ACCIDENT, GIRDERS SHALL BE PLACED AT CORRECT POSITION AS SHOWN ON THE DRAWINGS AND TEMPORARILY BRACED LATERALLY UNTIL DIAPHRAGMS/TRANSOMS AND DECK SLABS ARE CAST. THE ERECTION PROCESS SHALL NOT HINDER NORMAL MOVEMENT OF TRAFFIC.
- MULTISTRAND PRESTRESSING SYSTEM HAS BEEN USED IN THE DESIGN. FIXTURES AND DETAILS SHALL CONFORM TO ONE OF THE FOLLOWING SYSTEMS:-

 - FREYSSINET

 - STRONGHOLD
- PRESTRESSING STEEL SHALL CONFORM TO ASTM-416 (GRADE-270) WITH MINIMUM ULTIMATE STRENGTH OF 1860 N/sa.mm.
- ALL TENDONS SHALL BE STRESSED FROM ONE END ALTERNATELY UNLESS OTHERWISE SHOWN ON DRAWINGS AND SUBSTITUTION OF LIVE ANCHORAGE WITH BLIND ANCHORAGE FOR ONE - END STRESSING IS PERMITTED.

PROJECT: -

- IF ANCHORAGE PULL-IN OF STRANDS EXCEEDS 6 mm, THE TENDON SHALL BE DESTRESSED BY APPROVED MEANS AND SHALL BE RESTRESSED USING NEW SET OF GRIPS
- TENDONS SHALL BE STESSED AFTER THE CONCRETE HAS ATTAINED A CRUSHING STRENGTH OF 425 Kg/sq.cm. THE EXTENSIONS SHOWN IN DRAWINGS ARE THE TOTAL EXTENSION TO BE ACHIEVED BEFORE LOCKING AND ARE CALCULATED ON THE BASIS OF 200000 N/sq.mm AS MODULUS OF FLASTICITY OF STEEL: FOR OTHER VALUES OF MODULUS OF FLASATICITY, EXTENSIONS SHOULD BE CALCULATED ON PRO-RTA BASIS. TENDONS SHOULD NOT BE LOCKED IF THE ACTUAL EXTENSIONS VARY MORE THAN 10% FROM THE VALUES SHOWN OR CALCULATED AS THE CASE MAY BE AND THE MATTER REPORTED TO ENGINEER WHO SHALL GIVE FURTHER INSTRUCTION.
- PRESTRESSING TENDONS COMPRISE 0.5 INCHES DIAMETER 7 WIRES STRANDS IN NUMBERS STATED IN THE RESPECTIVE DRAWINGS.
- THE ORDER OF STRESSING SHALL BE AS STATED IN THE DRAWINGS. 20.
- 21. ANCHORAGE POCKET SHALL BE FILLED WITH CLASS A1 CONCRETE USING 12 mm DOWN AGGREGATES, AFTER GROUTING AND TRIMMING TENDONS.
- INTERMEDIATE GROUT VENTS SHALL BE PROVIDED AT ABOUT MID LENGTH OF THE TENDONS WHEN 22. TENDON LENGTH IS MORE THAN 12 METERS.
- ALL EXPOSED CORNERS OF CONCRETE TO BE CHAMFERED 25 mm x 25 mm EXCEPT OTHER WISE SHOWN
- ALL REINFORCED CONCRETE AND PRESTRESSED SHALL BE FAIR-FACED TO BE CAST IN STEEL FORMWORK AND PLATES OF NOT LESS THAN 3 mm THICKHNESS. TIMBER AND STEEL-CLAD TIMBER FORMWORK SHALL NOT BE ALLOWED.
- THE DESIGN AND THE ENGINEERING OF THE FORMWORK AND FALSEWORK AS WELL AS ITS CONSTRUCTION SHALL BE RESPONSIBILITY OF THE CONTRACTOR. DESIGN OF FORMWORK AND FALSEWORK SHALL COMPLY WITH THE SPECIFICATIONS AND IN GENERAL CONFORM TO ACL 318-95 AND ACL SP-4
- CONCRETE IN DECK SLAB SHALL BE PLACED IN FULL WIDTH. NO CONSTRUCTION JOINT SHALL BE PERMITTED EXCEPT AS MENTIONED IN THE DRAWING OF CONSTRUCTION SEQUENCE OF DECK SLAB.
- ELASTOMERIC BEARING PADS SHALL CONFORM TO SECTION 25, DIVISION 2 OF AASHTO STANDARD SPECIFICATIONS FOR HIGHWAY BRIDGES 1992 AS AMENDED IN 1994, FULLY
- BRIDGE BEARINGS SHALL BE PLACED IN HORIZONTAL POSITIONS. INCLINED OR TAPERED BEARINGS SHALL NOT BE ALLOWED.
- BEFORE COMMENCEMENT OF CONSTRUCTION OF PERMANENT PILES. TEST PILES 29. SHALL BE CONSTRUCTED. TESTED AND THE LOAD TEST RESULT SHALL BE SUBMITTED TO THE ENGINEER. WHO SHALL APPROVE OR AMMEND THE PILE TIP LEVEL.
- THE PILES SHALL BE BORED-CAST-IN-PLACE. THE WORKING LOAD AND DIAMETER OF THE PILE ARE STATED ON THE GENERAL ARRANGEMENT DRAWING
- THE PILING WORK SHALL BE EXECUTED USING APPROPRIATE PILING EQUIPMENT AND 31. METHODOLOGY TO BE APPROVED IN WRITING BY THE ENGINEER
- THE PILE TIP LEVELS ARE TENTATIVE AND TO BE CONFIRMED BY THE ENGINEER UPON COMPLETION OF SUBSOIL INVESTIGATION AND REPORT BY THE GEOTECHNICAL ENGINEER OF THE CONTRACTOR.
- CLEAR COVER TO REINFORCEMENT TO BE
 - 25 mm IN DECK SLAB & APPROACH SLAB (BOTTOM REINF.)
 - 40 mm IN DECK SLAB & APPROACH SLAB (TOP REINF.)
 - 25 mm IN BARRIER
 - 40 mm IN GIRDERS, TRANSOMS, DIAPHRAGMS (TOP & BOTTOM REINF.).
 - (d) 40 mm IN WALLS.
 - 50 mm IN PILECAP
 - 75 mm IN PILES & PIER SHAFTS UNLESS OTHERWISE SPECIFIED.
- FOR CORRECT FIXATION OF FINISHED DECK LEVELS OF BRIDGES LOCATED ON CURVES WITH SUPER ELEVATION, REFER TO PLAN AND PROFILE DRAWINGS PRIOR TO CASTING OF DECK SLAB.

LEGEND AND SYMBOLS

•	(IN ELEVATION OR SECTION) FINISHED SURFACE ELEVATION	
	REINFORCEMENT	
E.F.	EACH FACE	
EA	EACH	
R	RADIUS	
DWG.	DRAWING	
N.T.S.	NOT TO SCALE	
CRS	(ON) CENTRES	
I.F	INNER FACES	
O.F	OUTER FACES	
B.F.	BOTH FACES	
EL.	ELEVATION	
N/mm. ²	NEWTON PER SQUARE MILLIMETER.	
Т	TOP	
Ę	CENTRELINE	
В	воттом	
ALT	ALTERNATELY	
E.J.	EXPANSION JOINT	
C.J.	CONSTRUCTION JOINT	
N.S.I.E	NOT SHOWN IN ELEVATION	
N.S.I.P	NOT SHOWN IN PLAN	
	GANTRY	
\triangle	SYMMETRICAL	

CLIENT:-**ADB**

Asian Development Bank

EXECUTING AGENCY: -

WORKS AND SERVICES DEPARTMENT GOVERNMENT OF SINDH


LOAN NO. 4279-PAK (COL): EMERGENCY FLOOD ASSISTANCE PROJECT (EFAP)



PROJECT ROAD:-
DISTRICT : BENAZIRABAD - SB-02
IMPROVEMENT / REHABILITATION OF ROAD FROM 60TH MILE
CONNECT 3 CHAK VIA 68TH MILE AND CHAUDHARY NAZEER RC
TITLE:-

GENERAL NOTES

-02	ED.NO
ROM 60TH MILE TO	
IARY NAZEER ROAD	

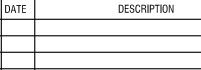

DRAWN: FAS DESIGNED: R.I / M.A


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JUNE 2023

DRAWING NO. 2053-STR-SB02-GN-01 Scale: 1.1


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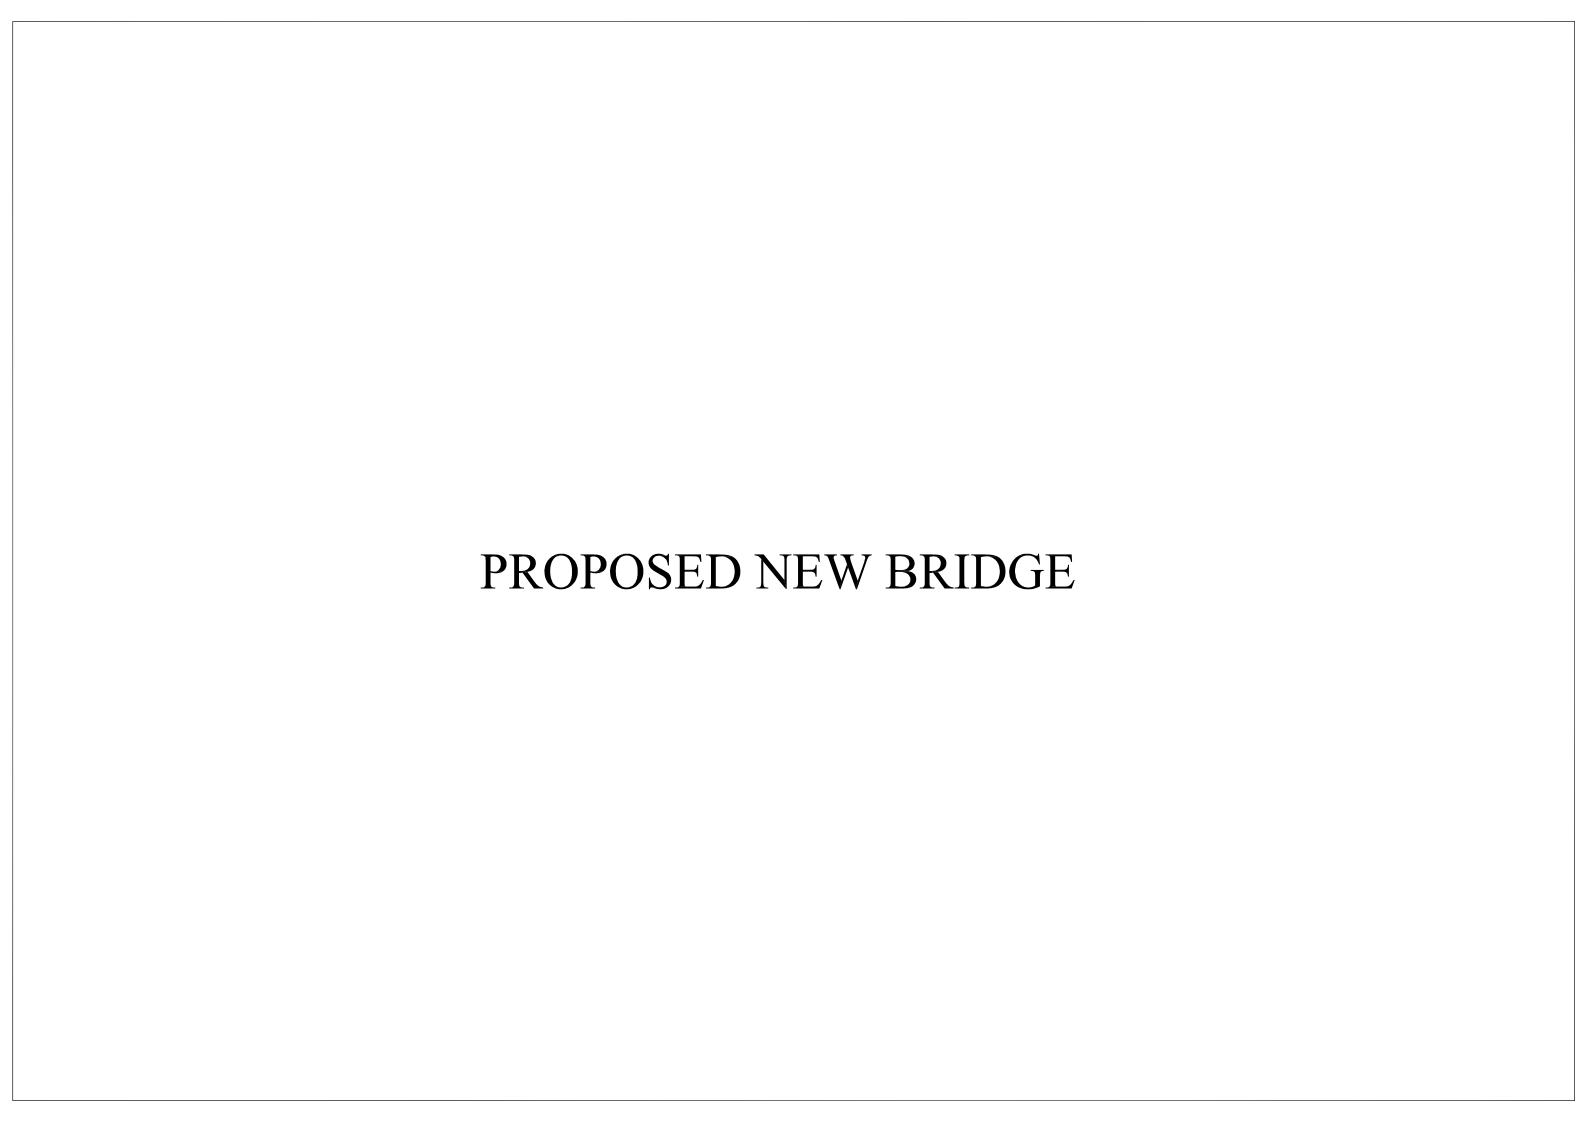
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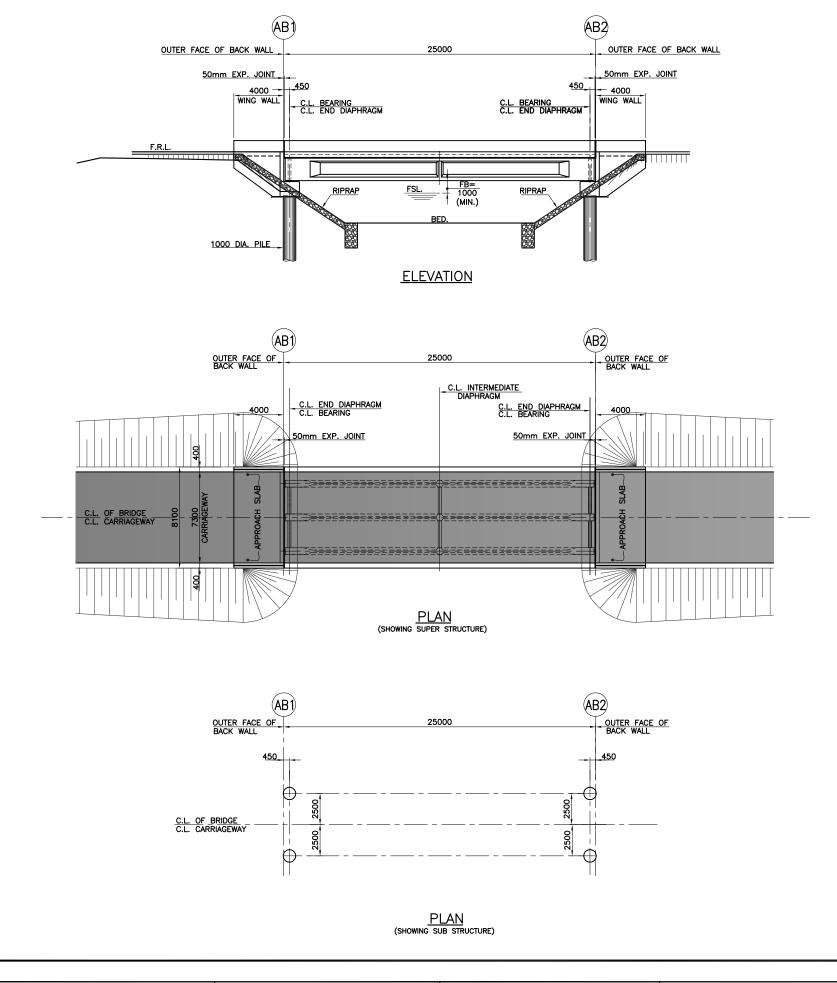



SCHEDULE OF BRIDGES

				EXI	STING BRID	GE		PROPOSED DESIGN						
BRIDGE NO.	LATITUDE	LONGITUDE	EXISTING/ PROPOSED	NO. OF SPANS	SPAN	TOTAL LENGTH	DESIGN STRATEGY	NO. OF SPANS	SPAN	TOTAL LENGTH	SKEW			
B1 26.37998		68.58780	PROPOSED	2	2.5	7.5	NEW	1	25	25	0			

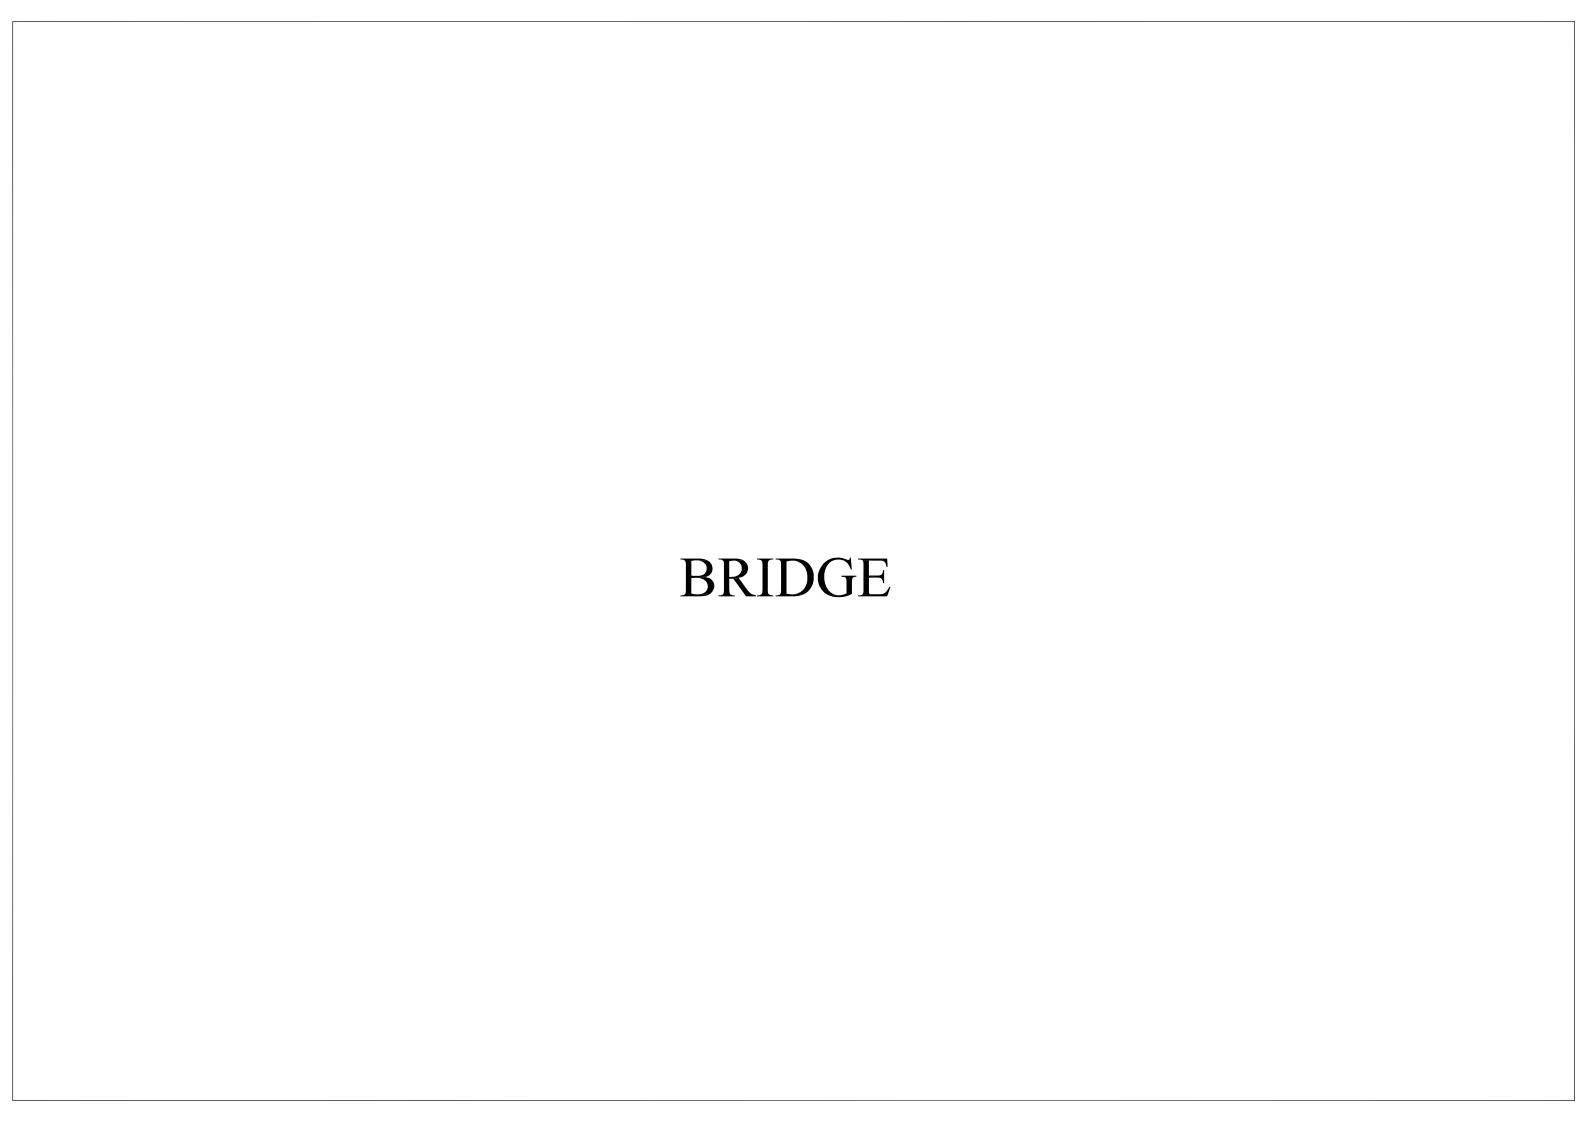





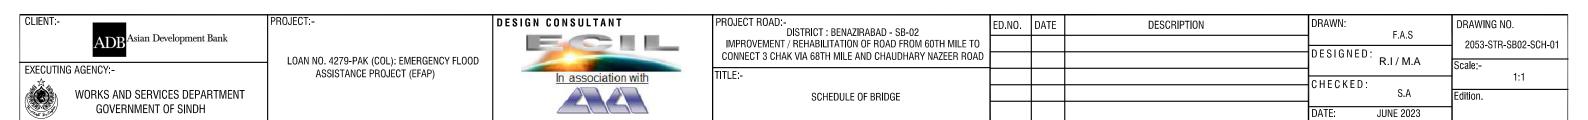

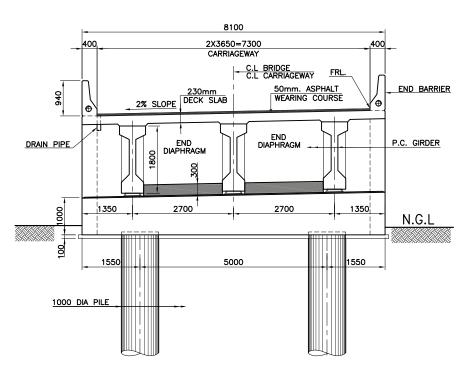

TYPICAL CROSS SECTION SCALE: 1:50

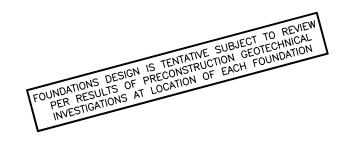


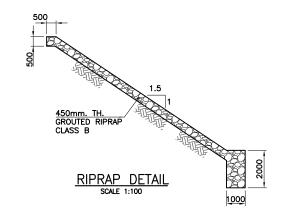



NOTES:

- 1 THIS DRAWING MUST BE READ IN CONJUNCTION WITH RELEVANT HIGHWAYS DWGS.
- 2 FOR GENERAL NOTES REFER DWG. NO. 2053-STR-SB02-GN-01.
- 3 ALL LEVELS SHALL BE VERIFIED AT SITE BEFORE CONSTRUCTION ANY DISCREPANCY FOUND, SHOULD BE IMMEDIATELY REPORTED TO ENGINEER.

CLIENT:-	PROJECT:-	DESIGN CONSULTANT		ED.NO.	DATE	DESCRIPTION	DRAWN:		DRAWING NO.
ADB ^{Asian Development Bank}			DISTRICT : BENAZIRABAD - SB-02 IMPROVEMENT / REHABILITATION OF ROAD FROM 60TH MILE TO				F.A.S		2053-STR-SB02-B1-101
EXECUTING AGENCY:-	LOAN NO. 4279-PAK (COL): EMERGENCY FLOOD		CONNECT 3 CHAK VIA 68TH MILE AND CHAUDHARY NAZEER ROAD				DESIGNED: R.I/M.	۹ <u> </u>	Scale:-
a Ša	ASSISTANCE PROJECT (EFAP)	In association with	TITLE:- BRIDGE NO. B1				CHECKED:		1:150
WORKS AND SERVICES DEPARTMENT			GENERAL ARRANGEMENT				S.A DATE: JUNE 2023		Edition.
GOVERNMENT OF SINDH			5=1=11.						

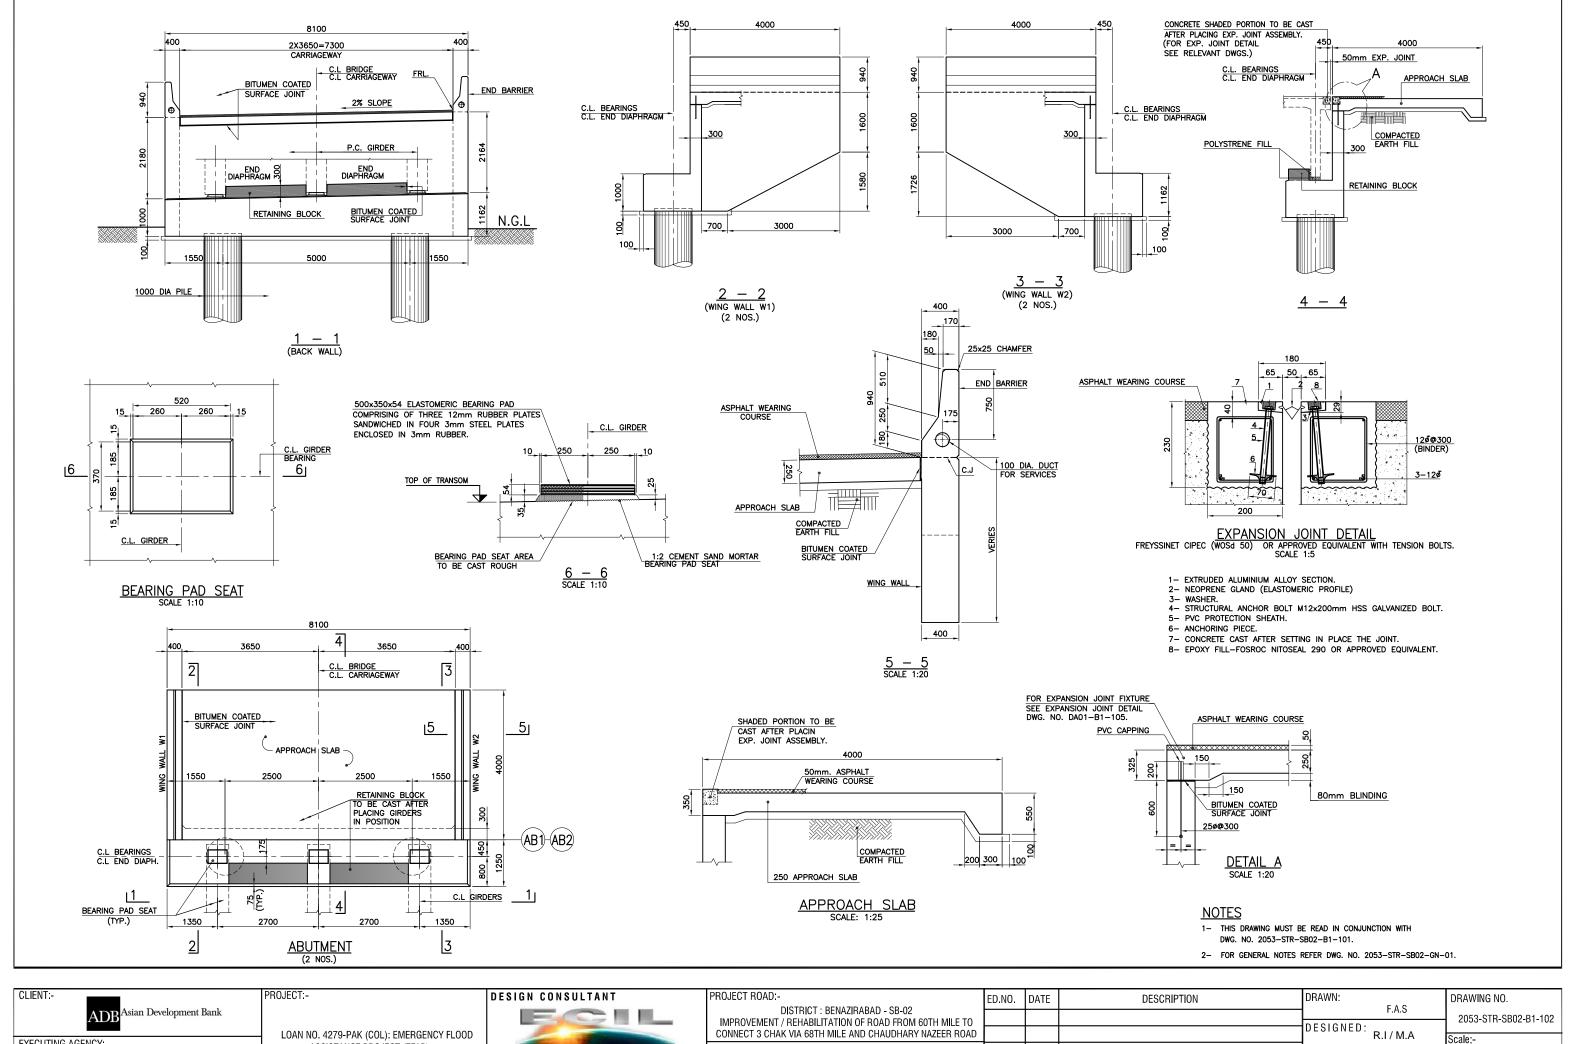

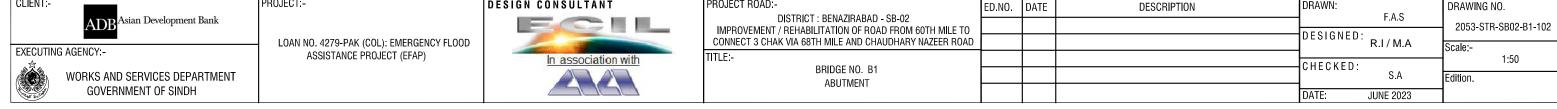


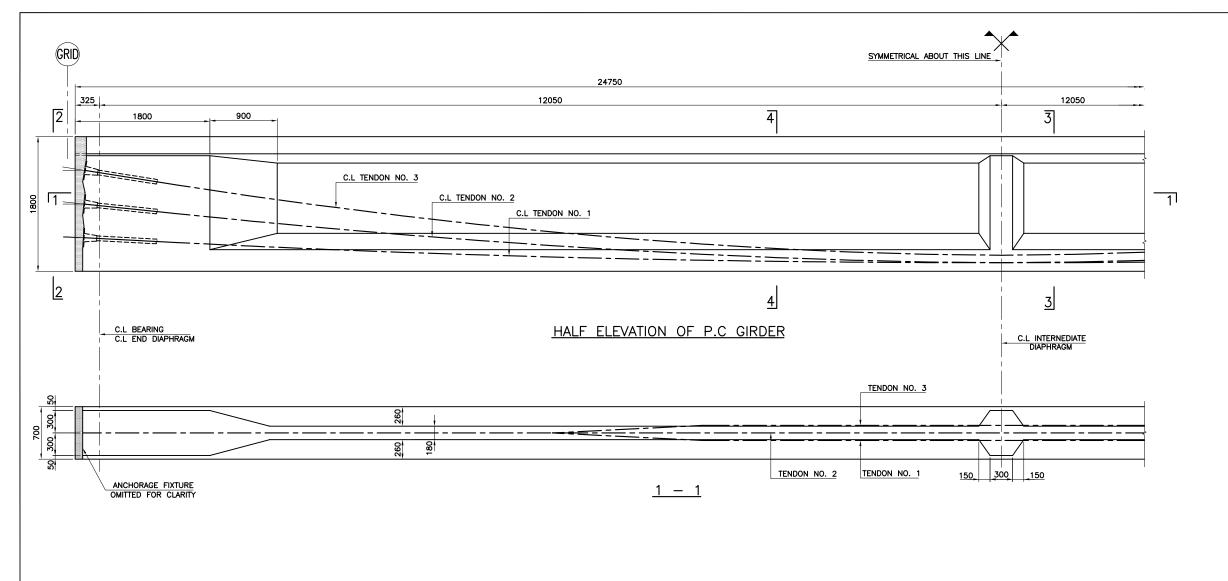

Т	EN	100	1 D	ATA			
TENDON NOS.	1		:	2	,	3	
ORDINATES	Y	z	Y	z	Y	z	
0000 C.L.GIRDER	-100	115	100	115	0	215	
1000	-100	116	100	125	0	227	
2000	-100	123	100	149	0	257	
3000	-100	133	100	183	0	303	
4000	-100	148	100	228	0	364	
5000	-75	167	75	281	0	438	
6000	-50	191	50	343	0	526	
7000	0	220	0	413	0	627	
8000	0	253	0	490	0	740	
9000	0	292	0	576	0	866	
10000	0	335	0	668	0	1003	
11000	0	384	0	768	0	1152	
ORDER OF STRESSING	Å	\		В		С	
ELONGATION	18	0	17	9	179		
JACKING FORCE (KN)	17	63	17	63	1763		

TENDON ORDINATES AT END OF STRAIGHT LENGTH

TENDON NOS.	x	z
1	11288	399
2	11284	798
3	11283	1197

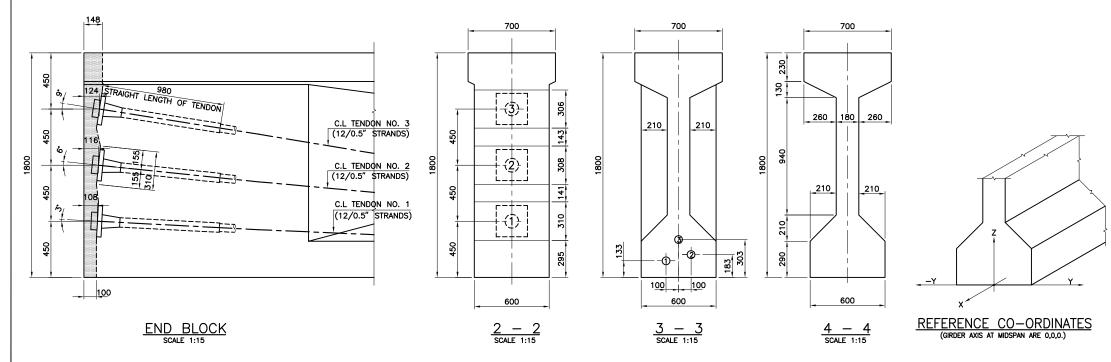



NOTES:

- 1 ALL STRANDS IN TENDON Nos. 1, 2 & 3 SHALL BE STRESSED FROM ONE END ONLY.
- 2 ALL STRANDS IN TENDONS SHALL BE STRESSED TO A MAX. LOAD OF 147 KN EACH AND LOCKED .
- 3 THE ANCHORAGE POCKET DETAILS SHOULD BE CHECKED BY THE CONTRACTOR FOR COMPATIBILITY WITH JACK PROPOSED TO BE USED BY HIM.
- 4 THE TOTAL EXTENSION GIVEN IN THE TABLE ARE CALCULATED ON THE FOLLOWING


'E',MODULUS OF ELASTICITY OF STEEL = 2.0E5 N/sq.mm JACK OVER LENGTH BEYOND FACE OF ANCHORAGE = 300 mm


- 5 THE PRECAST GIRDERS SHALL BE PLACED IN SPANS BY APPROVED MEANS TO ENSURE THEIR PLACEMENT WITHOUT DAMAGE AND ACCIDENT. GIRDER SHALL BE PLACED AT CORRECT POSITIONS AS SHOWN ON THE DRAWINGS AND TEMPORARILY BRACED LATERALLY UNTIL DIAPHRAGMS AND DECK SLABS ARE CAST.
- 6 THE CONTRACTOR SHALL PREPARE SHOP DRAWINGS OF:
- (a) FORMWORK, (b) STEEL TUBES, & (c) ANCHOR POCKET DETAILS.
- 7 CONTRACTOR SHALL PROPOSE LIFTING ARRANGEMENT OF THE GIRDER FOR APPROVAL BY THE ENGINEER.
- 8 FOR GENERAL NOTES REFER DRG. NO. 2053-STR-SB02-GN-01.

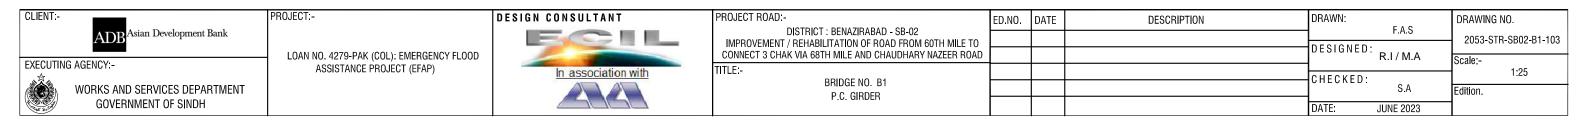


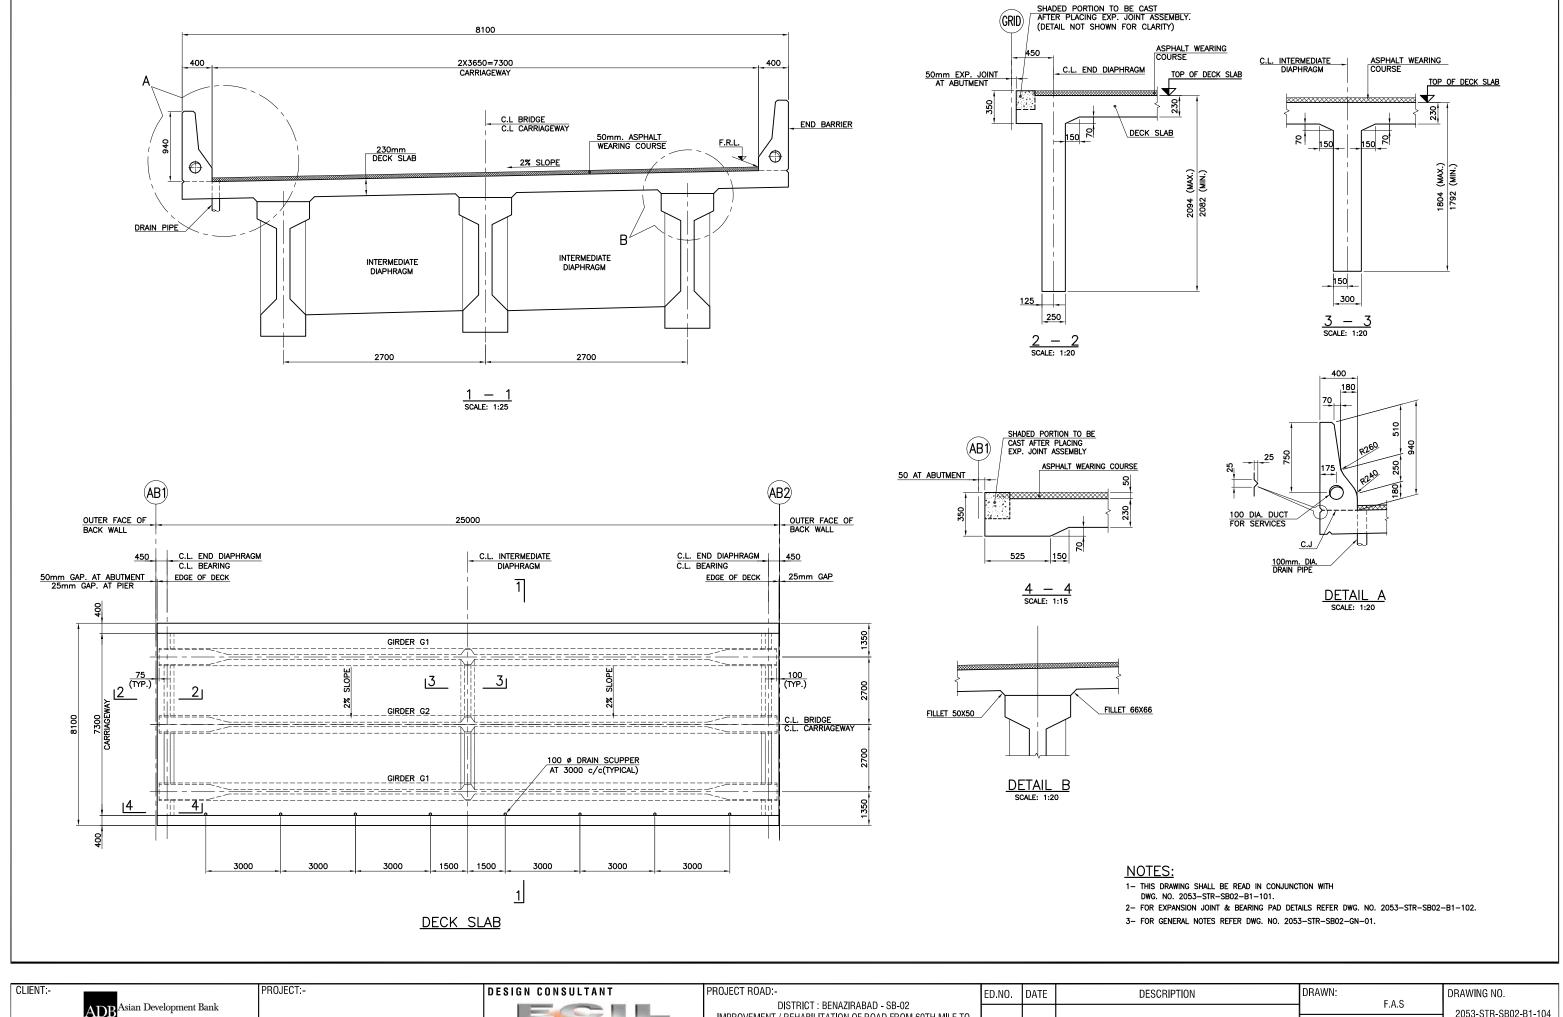





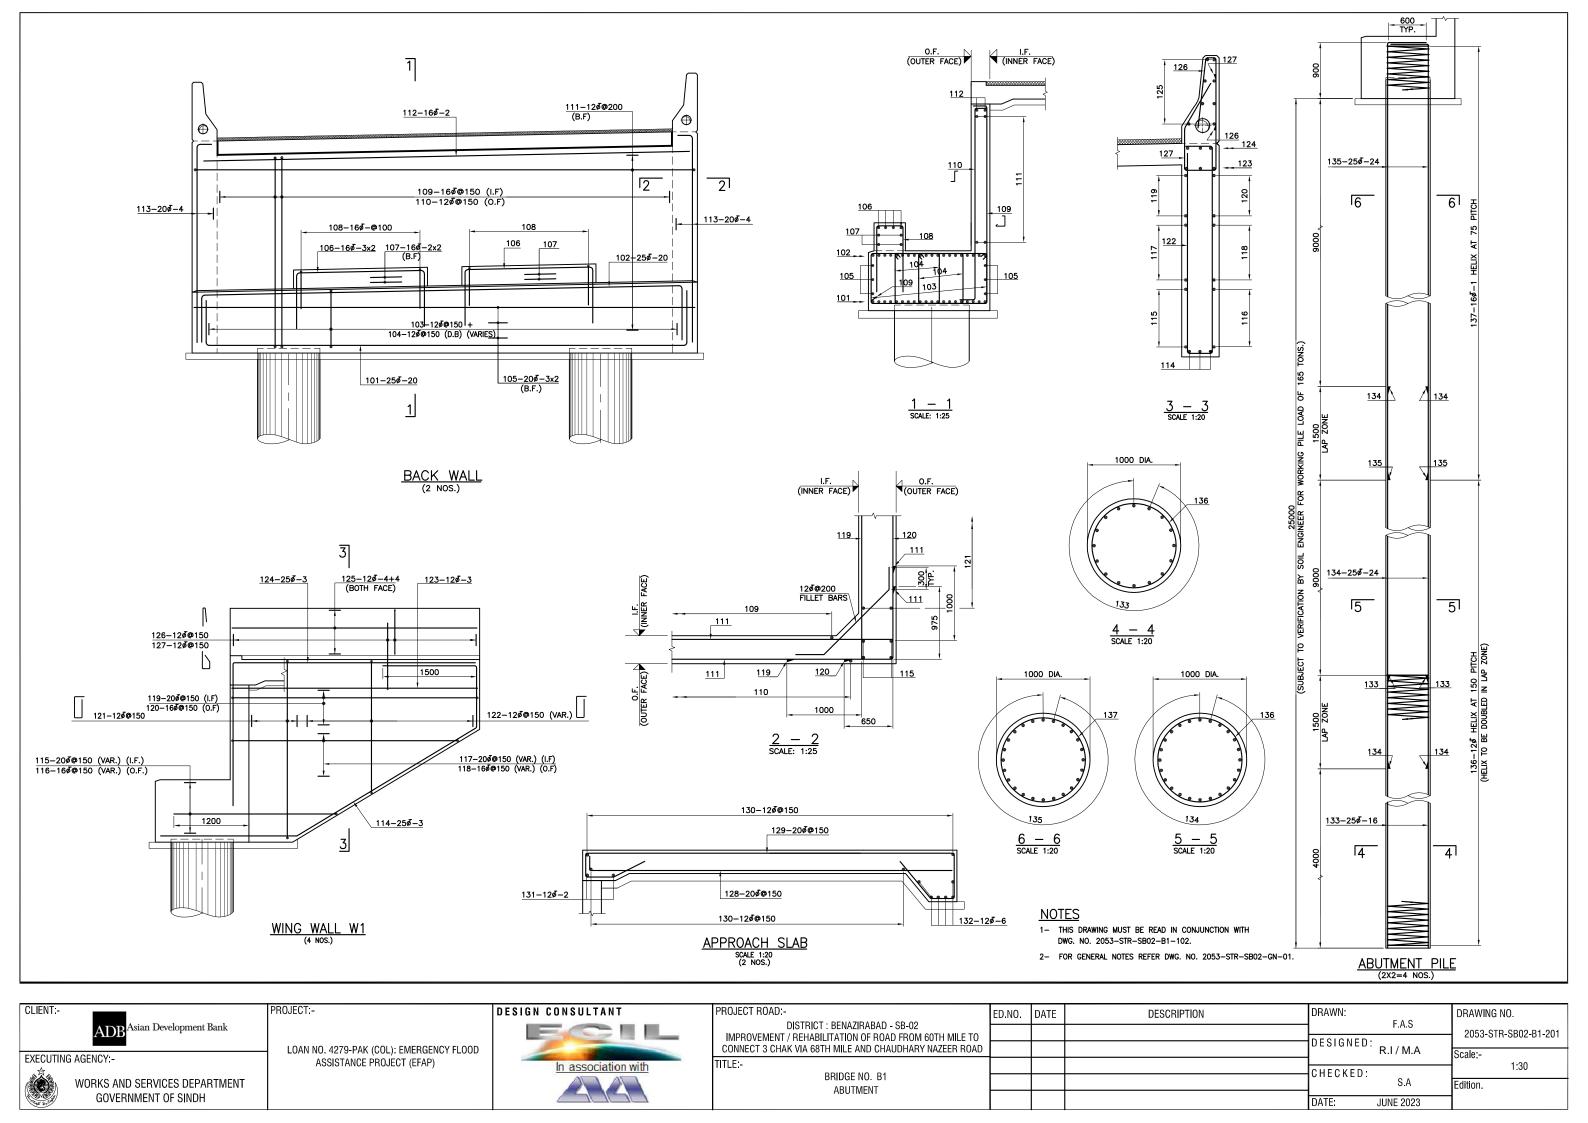


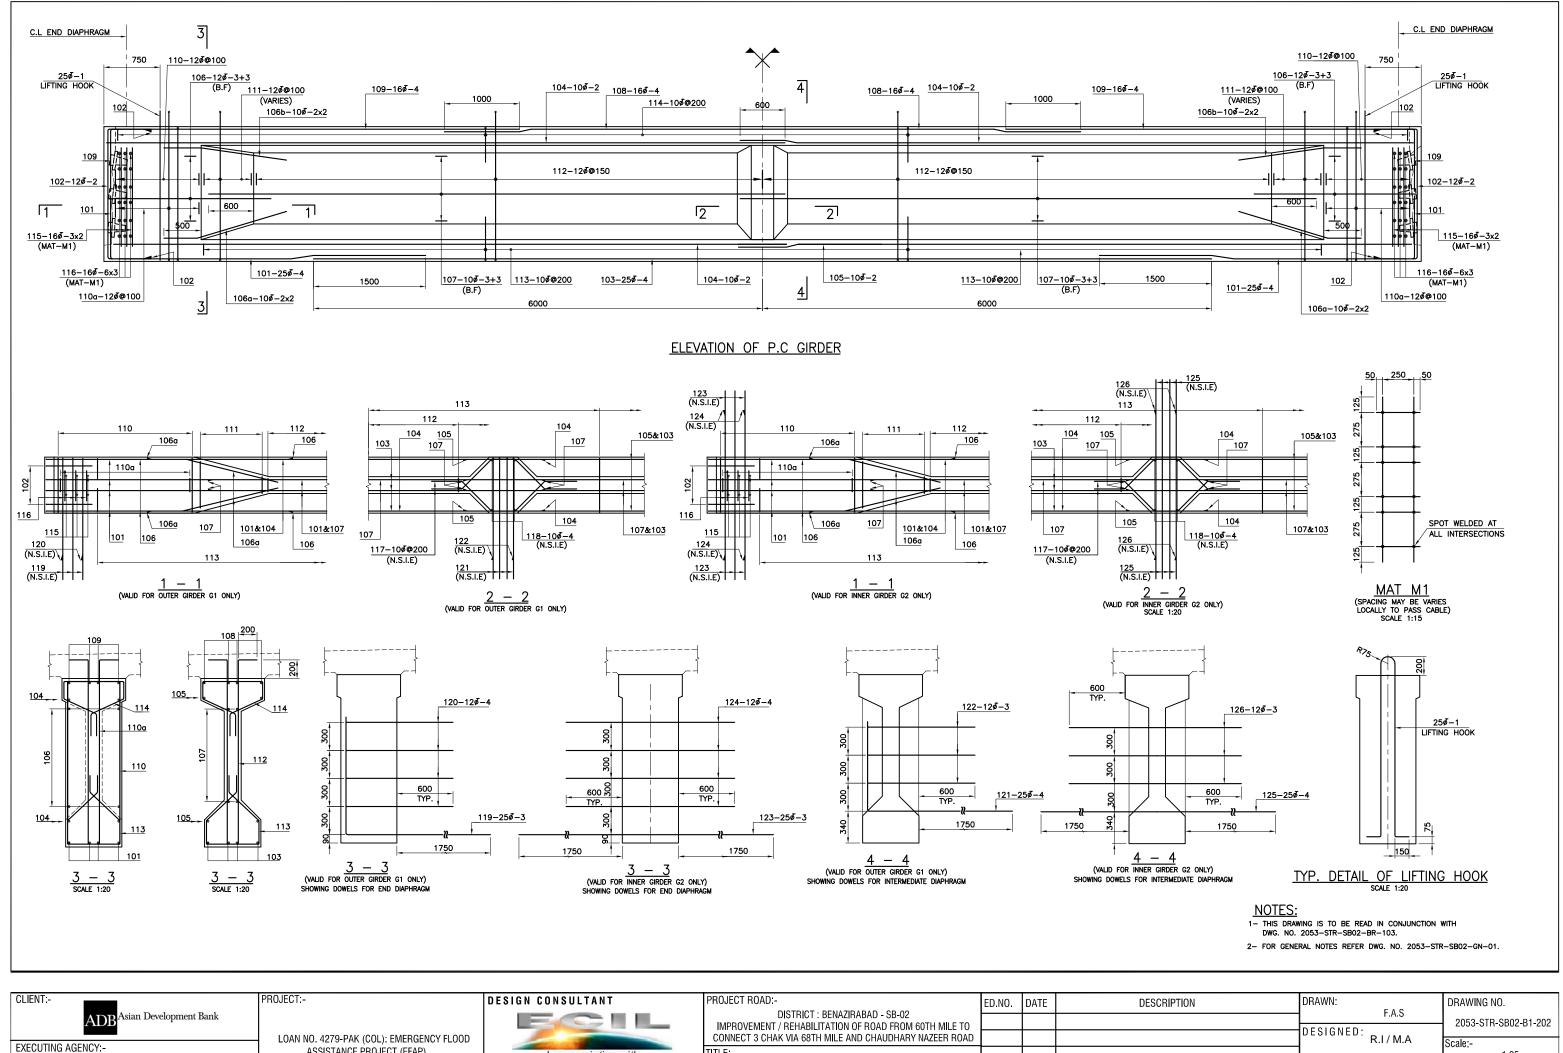


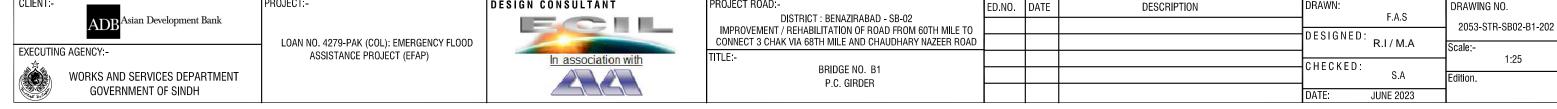

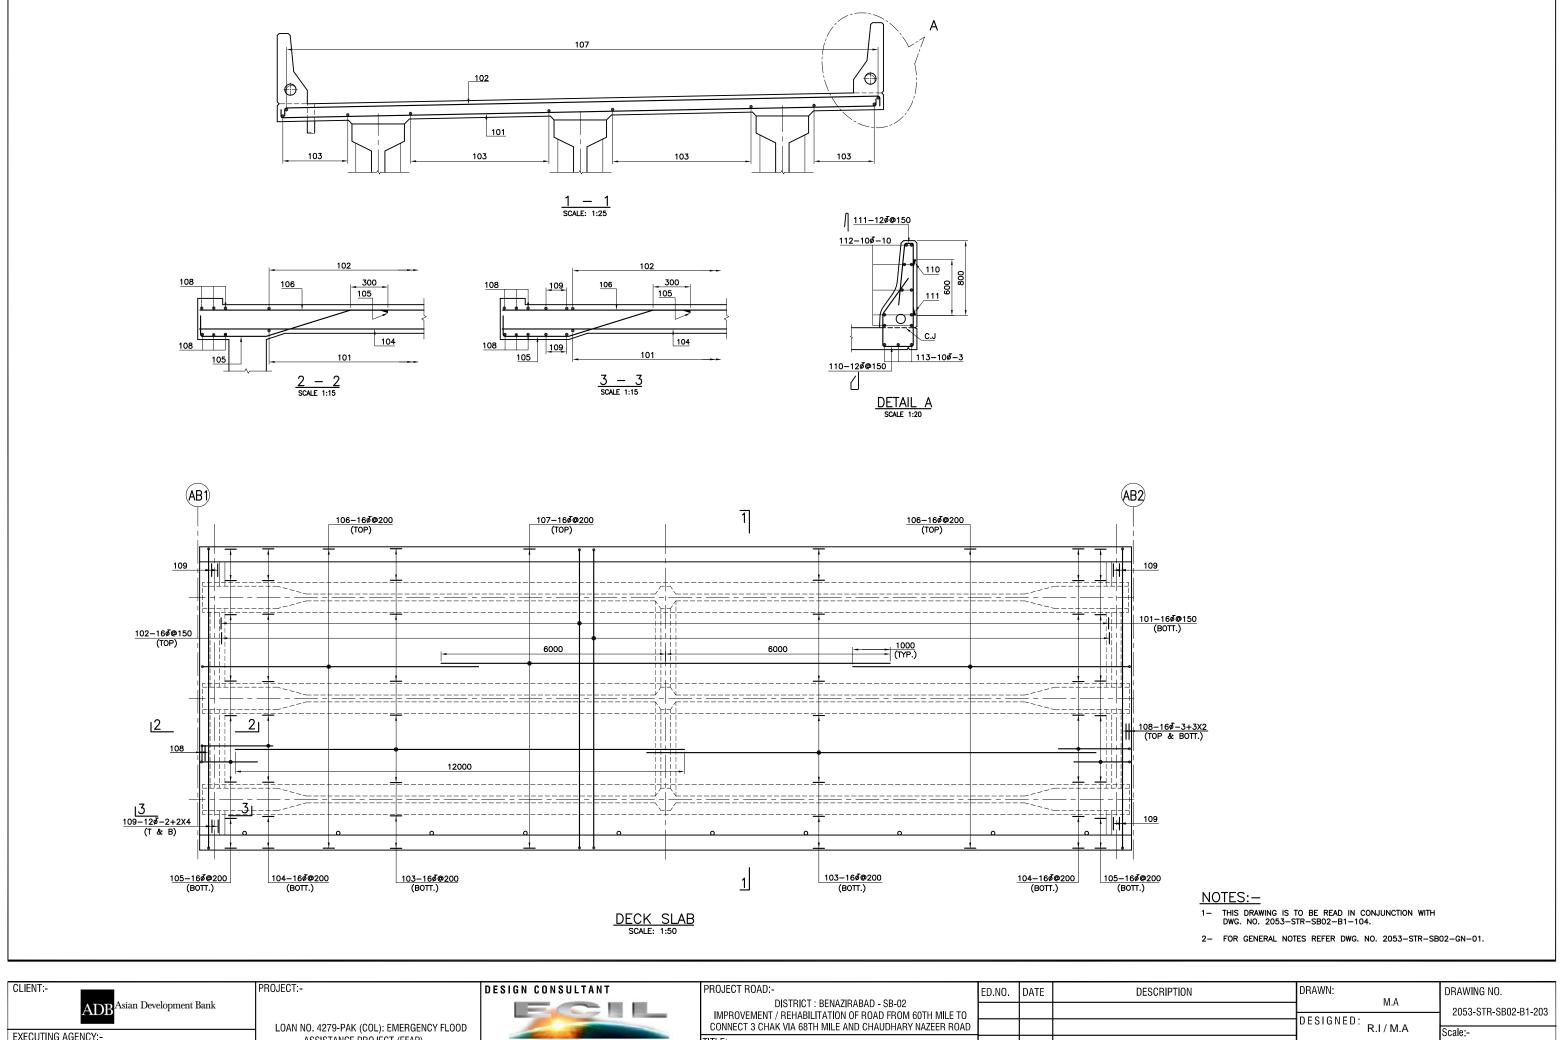


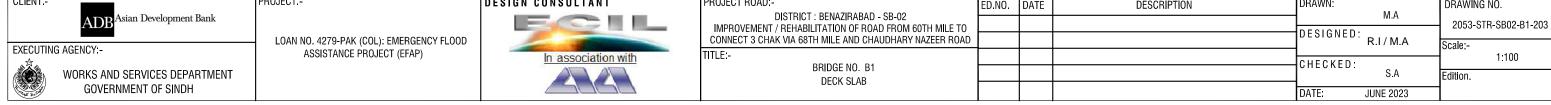


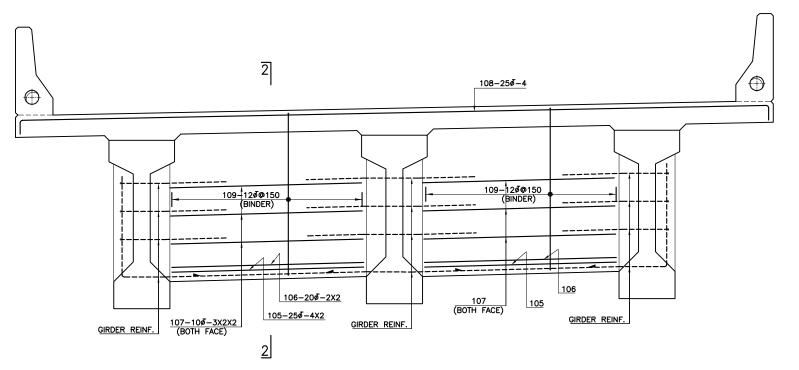

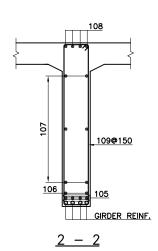



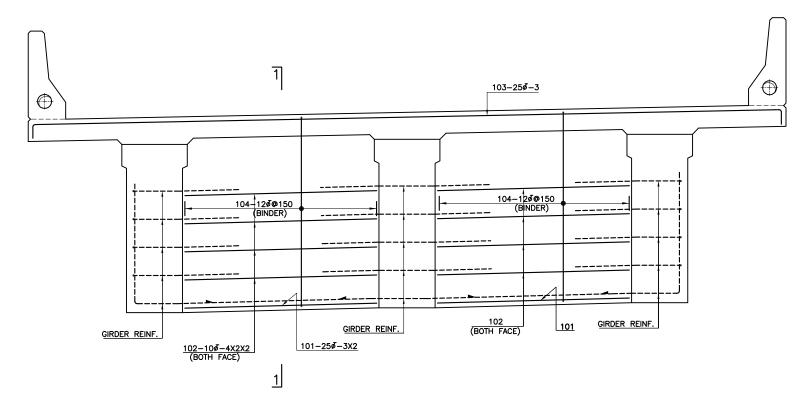

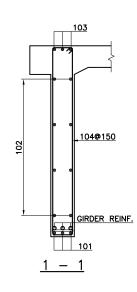


END DIAPHRAGM (2 Nos.)

NOTES:-

- 1- THIS DRAWING IS TO BE READ IN CONJUNCTION WITH DWG. NO. 2053-STR-SB02-B1-104.
- 2- FOR GENERAL NOTES REFER DWG. NO. 2053-STR-SB02-GN-01.

CLIENT:-	PROJECT:-	DESIGN CONSULTANT	PROJECT ROAD:-	ED.NO.	DATE	DESCRIPTION	DRAWN:	DRAWING NO.
ADB ^{Asian} Development Bank			DISTRICT : BENAZIRABAD - SB-02 IMPROVEMENT / REHABILITATION OF ROAD FROM 60TH MILE TO				DESIGNED	2053-STR-SB02-B1-204
EXECUTING AGENCY:-	LOAN NO. 4279-PAK (COL): EMERGENCY FLOOD ASSISTANCE PROJECT (EFAP)	In association with	CONNECT 3 CHAK VIA 68TH MILE AND CHAUDHARY NAZEER ROAD TITLE:-				R.I / M.A	Scale:- 1:20
WORKS AND SERVICES DEPARTMENT			BRIDGE NO. B1 DIAPHRAGMS				CHECKED: S.A	Edition.
GOVERNMENT OF SINDH			DIVIT TITUTCINO				DATE: JUNE 2023	1

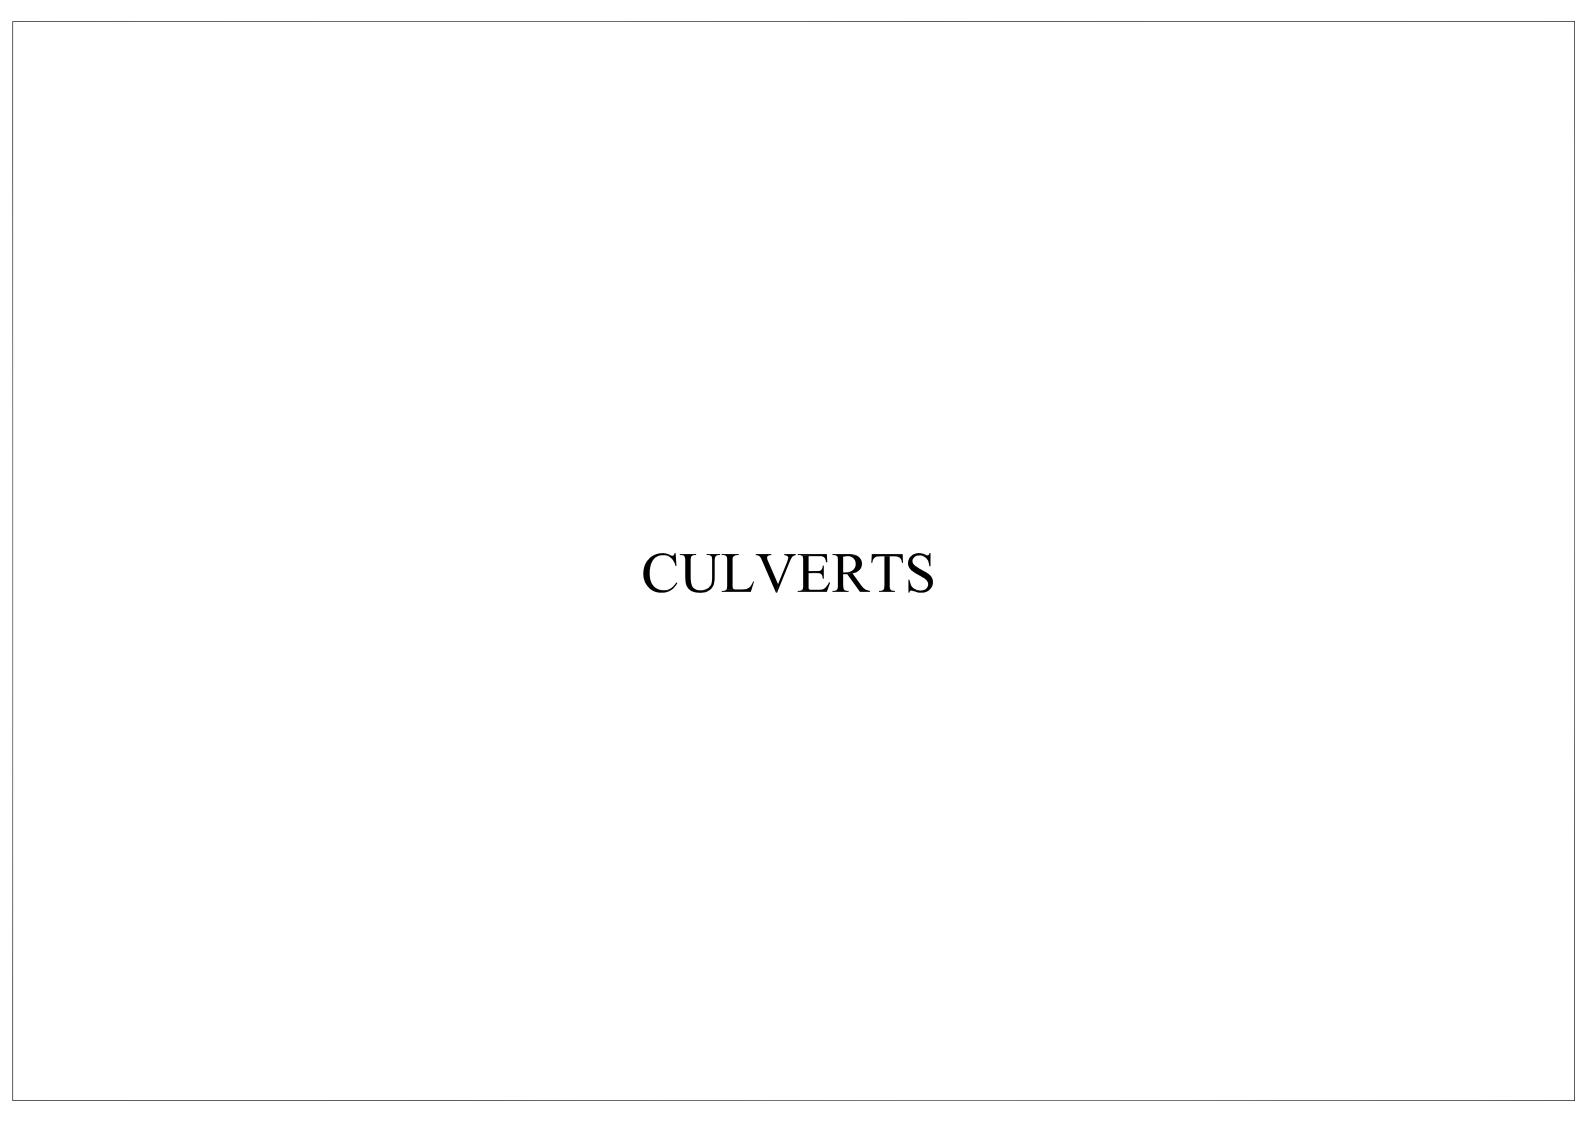

SCHEDULE OF CULVERTS

				EX	ISTING CULVE	RT		PROPOSED DESIGN						
CULVERT NO.	LATITUDE	LONGITUDE	EXISTING/ PROPOSED	NO. OF CELLS	WIDTH/ DIA	HEIGHT	DESIGN STRATEGY	TYPE	NO. OF CELLS	WIDTH/ DIA	HEIGHT			
C1	26.44649	68.57254	EXISTING	1	1	1	REPLACE WITH NEW	вох	1	1.5	1			
C2	26.44630 68.573		EXISTING	1	1	1	REPLACE WITH NEW	вох	1	1.5	1			
C3	26.43647	68.58077	EXISTING	1	1	1	REPLACE WITH NEW	вох	1	1.5	1			
C4	26.43137	68.58311	EXISTING	1	1	1	REPLACE WITH NEW	вох	1	1.5	1			
C5	26.42839	68.58399	EXISTING	1	1	1.5	REPLACE WITH NEW	вох	1	1.5	1.5			
C6	26.42433	68.58515	EXISTING	1	1.5	1.5	REPLACE WITH NEW	вох	1	1.5	1.5			
C7	26.41169	68.58723	EXISTING	1	1	1	REPLACE WITH NEW	вох	1	1.5	1			
C8	26.40630	68.58096	PROPOSED	-	-	-	NEW	вох	1	1.5	1.5			
C9	26.40220	68.58052	EXISTING	1	0.3	0.3	REPLACE WITH NEW	PIPE	1	1	-			
C10	26.39725	68.58063	EXISTING	1	1	1.5	REPLACE WITH NEW	вох	1	1.5	1.5			
C11	26.39682	68.58654	EXISTING	1	1	1	REPLACE WITH NEW	вох	1	1.5	1			
C12	26.39280	68.58809	PROPOSED	-	-	-	NEW	вох	1	1.5	1.5			
C13	26.37476	68.58780	EXISTING	1	1	1	RETAINED/ REPAIR	-	-	-	-			
C14	26.37264	68.58768	PROPOSED	-	-	-	NEW	PIPE	1	1	-			
C15	26.35761	68.58460	EXISTING	1	1	1.5	REPLACE WITH NEW	вох	1	1.5	1.5			
C16	26.35780	68.57959	EXISTING	1	1	1	REPLACE WITH NEW	PIPE	2	1	-			
C17	26.35420	68.57691	EXISTING	1	1	1	REPLACE WITH NEW	вох	1	1	1			
C18	26.35324	68.57688	EXISTING	1	1	1	REPLACE WITH NEW	PIPE	3	1	-			
C19	26.35300	68.57421	EXISTING	1	0.3	0.3	REPLACE WITH NEW	вох	1	1.5	1			
C20	26.35319	68.57103	EXISTING	1	1	1.5	REPLACE WITH NEW	вох	1	1.5	1.5			
C21	26.34335	68.56624	EXISTING	1	0.3	0.3	REPLACE WITH NEW	PIPE	1	1	-			
C22	26.33397	68.54493	EXISTING	1	1	1	RETAINED/ REPAIR	-	-	-	-			
C23	26.33636	68.53565	EXISTING	1	2	2	RETAINED/ REPAIR	-	-	-	-			
C24	26.33965	68.53404	EXISTING	1	1	1	REPLACE WITH NEW	вох	1	1.5	1			
C25	26.33986	68.53417	EXISTING	1	1	1	REPLACE WITH NEW	вох	1	2	1			
C26	26.34327	68.53433	EXISTING	1	1.5	1	RETAINED/ REPAIR	-	-	-	-			
C27	26.34445	68.53434	EXISTING	1	1	1	REPLACE WITH NEW	вох	1	1.5	1			
C28	26.34677	68.53423	EXISTING	1	1	1	RETAINED/ REPAIR	-	-	-	-			
C29	26.34877	68.53443	EXISTING	1	1	1	REPLACE WITH NEW	вох	1	1.5	1			
C30	26.34906	68.53433	EXISTING	1	1	1	REPLACE WITH NEW	вох	1	2	1			
C31	26.34939	68.52535	EXISTING	1	0.3	0.3	REPLACE WITH NEW	вох	1	1	1			
C32	26.35127	68.51790	EXISTING	1	1.5	1.5	REPLACE WITH NEW	вох	1	2	1.5			
C33	26.35132	68.51968	EXISTING	1	1.5	1.5	REPLACE WITH NEW	вох	1	1.5	1.5			
C34	26.35819	68.50774	EXISTING	1	1	1	RETAINED/ REPAIR	-	-	-	-			
C35	26.35841	68.50714	EXISTING	1	1	1	REPLACE WITH NEW	вох	1	1.5	1			
C36	26.36085	68.50136	EXISTING	1	1	1	REPLACE WITH NEW	вох	1	1.5	1			
C37	26.36585	68.48792	EXISTING	1	1	1	REPLACE WITH NEW	вох	1	1.5	1			
C38	26.36706	68.48461	EXISTING	1	4	1.5	RETAINED/ REPAIR	-	-	-	-			
C39	26.36845	68.48253	EXISTING	1	1	1	RETAINED/ REPAIR	-	-	-	-			
C40	26.36961	68.47964	EXISTING	1	1	1	REPLACE WITH NEW	вох	1	1.5	1			
C41	26.37384	68.46798	EXISTING	1	1	1	REPLACE WITH NEW	вох	1	1.5	1			
C42	26.37847	68.46023	EXISTING	1	1	1	RETAINED/ REPAIR	-	-	-	-			
C43	26.38053			1	REPLACE WITH NEW	вох	1	1.5	1					
C44	26.39212 68.44868 EXISTING 1 1 1			REPLACE WITH NEW	вох	1	1.5	1						
C45	26.39437 68.44656 EXISTING 1 1 1			RETAINED/ REPAIR	-		-	-						
C46	26.39527 68.44580 EXISTING 1 1 1.2			RETAINED/ REPAIR	_		_	_						
C47	26.39544	68.44562	EXISTING	1	1	1.2	RETAINED/ REPAIR	_		_	-			
C48	26.39553	68.44560	EXISTING	1	1	1.2	REPLACE WITH NEW	BOX	1	1.5	1			
C48			EXISTING	1	0.8	0.8	REPLACE WITH NEW	вох	1	1.5	1			
U-10	20.40000	68.44205	LAUTING	'	1 0.0	0.0	THE BOL WITHING		<u> </u>	1.5	'			

NOTES:-

- 1- THIS DRAWING MUST BE READ IN CONJUNCTION WITH RELEVANT HIGHWAY DRAWINGS.
- 2- ALL LEVELS SHALL BE VERIFIED AT SITE BEFORE EXECUTION.
- 3- LEVELS, LENGTHS & SKEWS MAY BE ADJUSTED AS PER SITE CONDITIONS DURING LEVELS ADJUSTMENTS, IF FILL HEIGHT VARIES SIGNIFICANTLY FOR WHICH THE STRUCTURE IS DESIGNED, NOTIFY ENGINEER.

DRAWING NO.

Scale:-

Edition.

2053-STR-SB02-CU-SCH-01

1:100

CLIENT:
ADB Asian Development Bank

EXECUTING AGENCY:-

WORKS AND SERVICES DEPARTMENT GOVERNMENT OF SINDH PROJECT:- DESIGN CONSULTANT


LOAN NO. 4279-PAK (COL): EMERGENCY FLOOD ASSISTANCE PROJECT (EFAP)





PROJECT ROAD:-
DISTRICT : BENAZIRABAD - SB-02
IMPROVEMENT / REHABILITATION OF ROAD FROM 60TH MILE TO
CONNECT 3 CHAK VIA 68TH MILE AND CHAUDHARY NAZEER ROAL
TITLE:-
···=-


SCHEDULE OF CULVERTS


	ED.NO.	DATE	DESCRIPTION	DRAWN:	E A C
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D				DESIGNED:	R.I / M.A
					R.I / M.A
				CHECKED:	
				OHECKED.	S.A
				DATE:	JUNE 2023

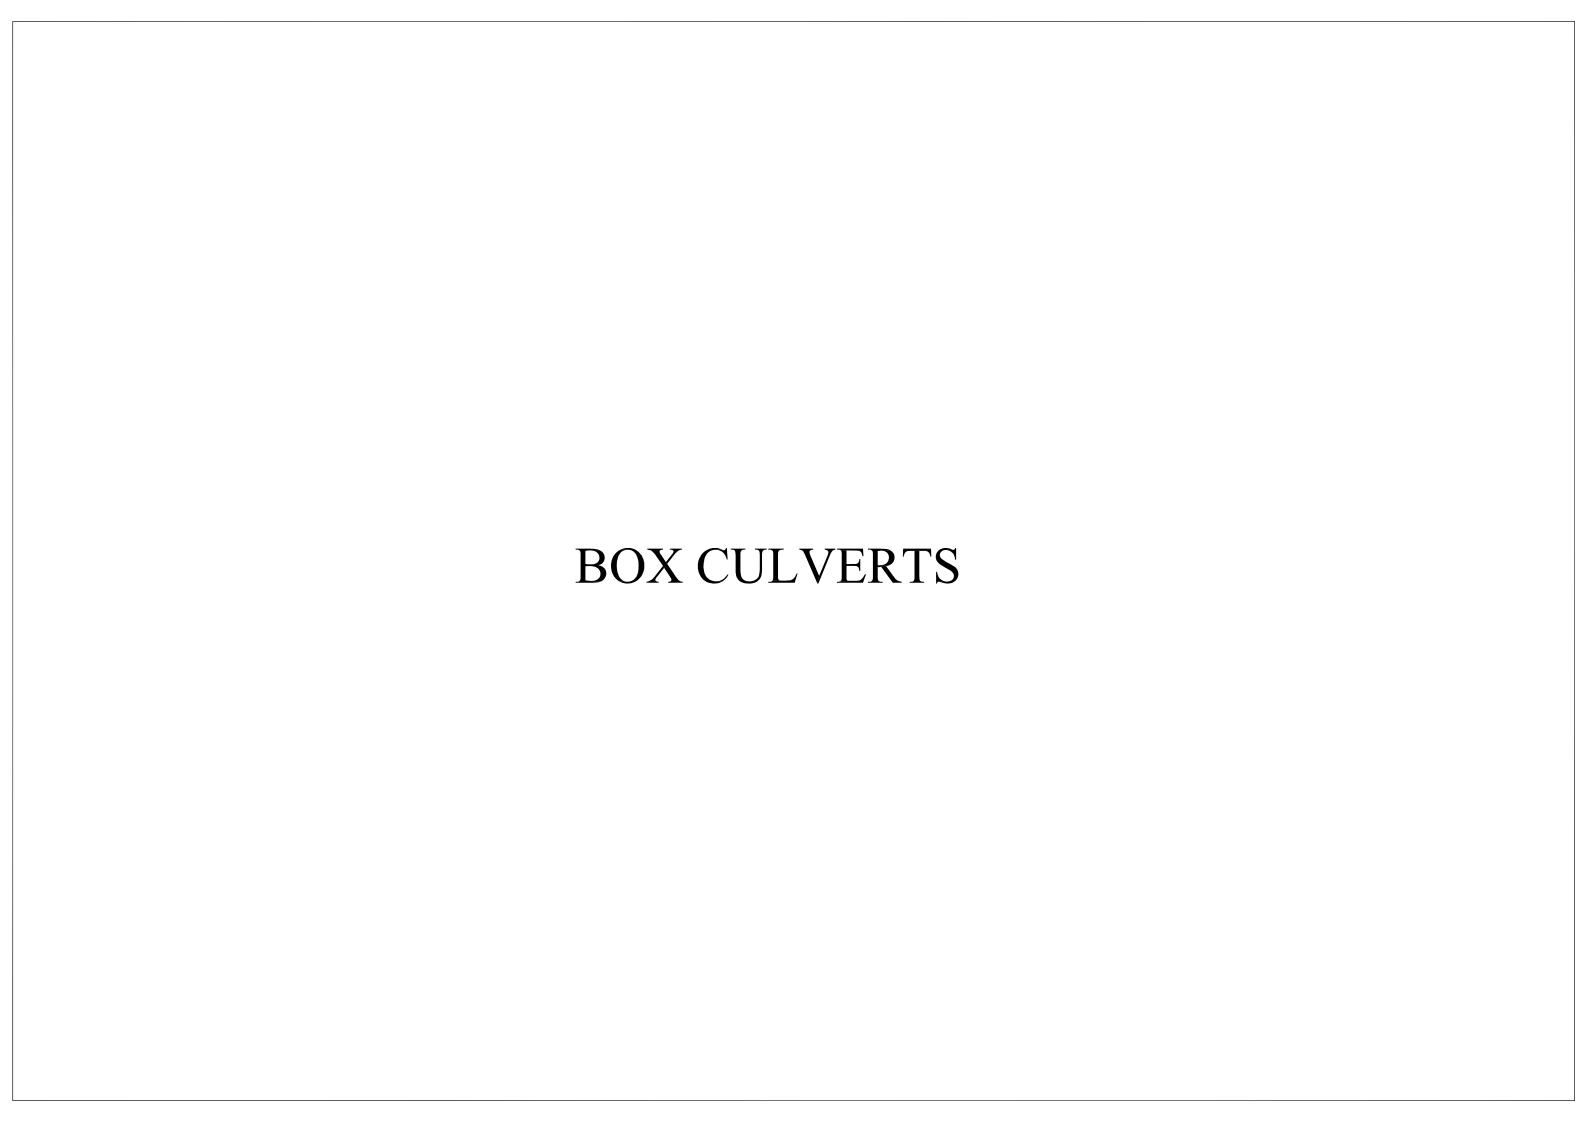

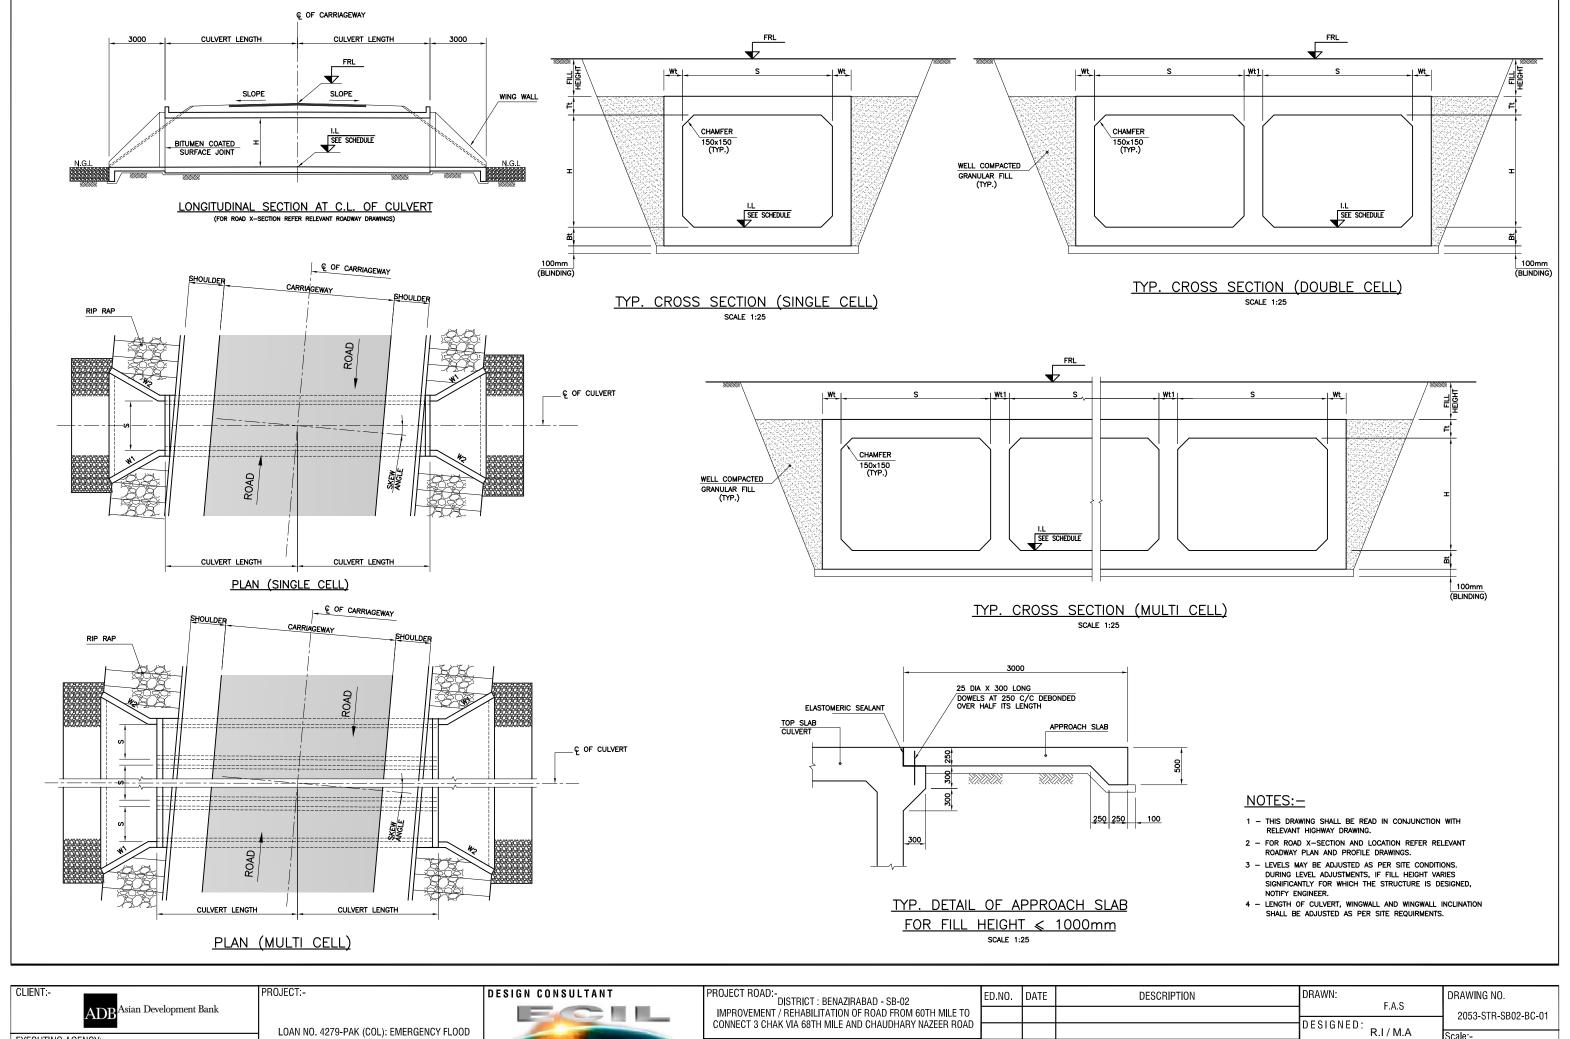

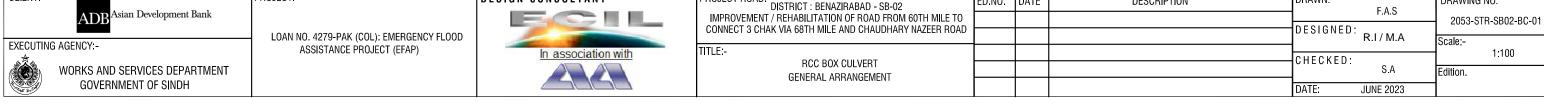


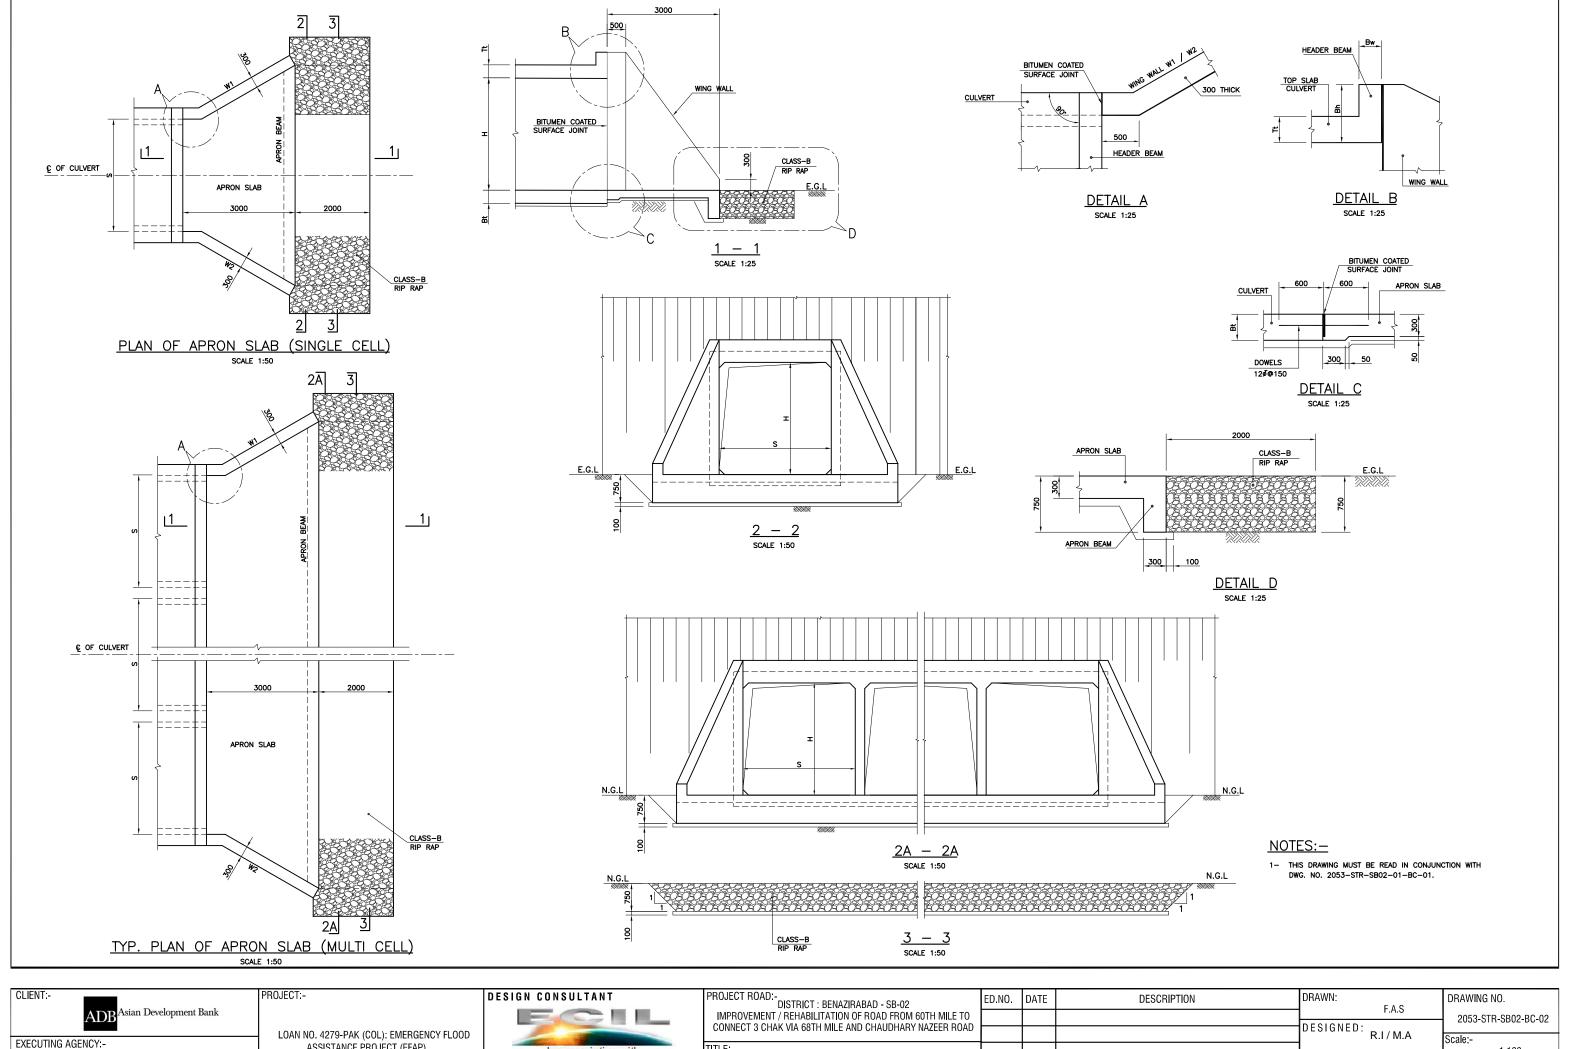

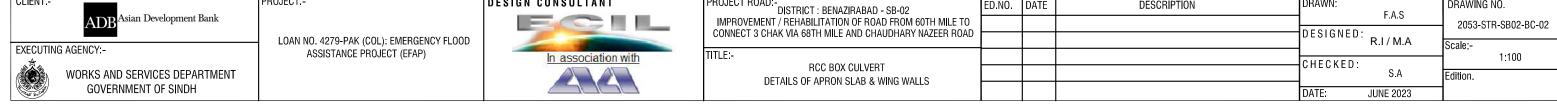


SINGLE CELL CULVERTS


		DIMENSIO)NS							Straight							Straight		Straight		traight			Straight	
						В	AR A	BAI	R B	BAR C		BAR D		BAR E		BAR F		BAR G		BAR H		BAR J		BAR K	
NO. OF CELLS	S H mm mm	FILL mm	Wt mm	Bt mm	Tt mm	DIA	SPACING	DIA	SPACING	DIA	SPACING	DIA	SPACING	DIA	NO.OF BAR										
1	1000 1000	300-1000	250	250	250	10₫	200	10₫	200	10₫	200	10₫	150	10 ¢	125	10 ४	200	10¢	200	10ø	200	10₫	200	10 ∛	8
1	1000 1500	300-1000	250	250	250	10₫	200	10₫	200	10₫	200	10₫	125	10₫	125	10 ø	200	10¢	200	10ø	200	10₫	200	10₫	8
1	1500 1000	300-1000	250	250	250	10¢	100	10₫	200	10₫	150	12 	125	12 ø	125	10¢	150	10¢	200	10ø	200	10 ĕ	200	10 ¢	8
1	1500 1500	300-1000	250	250	250	10₫	100	10₫	200	10₫	150	12 	125	12 ∛	125	10 ø	150	10 ¢	200	10¢	200	10₫	200	10 	8
1	1500 2000	300-1000	250	250	250	10₫	100	10₫	200	10₫	150	12 	125	12 	125	10 ४	150	10 ¢	200	10 ĕ	200	10₫	200	10₫	8
1	2000 1000	300-1000	300	300	300	12 ¢	125	10 ĕ	150	12 	150	12 	100	12 	100	12 ø	150	10 ø	200	10¢	200	10₫	200	10₫	8
1	2000 2500	300-1000	300	300	300	12¢	125	10₫	150	12 	150	16¢	150	16₫	125	12¢	150	10¢	200	10¢	200	10∉	200	10 ¢	8
1	2000 1500	300-1000	300	300	300	12 ¢	125	10₫	150	12 ∛	150	12 	100	12 ¢	100	12 ∛	150	10 ∛	200	10¢	200	10₫	200	10 	8
1	2000 2000	300-1000	300	300	300	12¢	125	10₫	150	12 	150	12¢	100	12 	100	12¢	150	10¢	200	10¢	200	10∉	200	10 ¢	8
1	2500 1000	300-1000	300	325	325	12₫	100	12 ¢	200	12 	100	16 ĕ	125	16₫	125	12 0	100	10 ĕ	200	10ø	200	10 ø	200	10 ¢	8
1	2500 1500	300-1000	300	325	325	12¢	100	12 	200	12 	100	16¢	125	16₫	125	12 ¢	100	10 ĕ	200	10 ĕ	200	10₫	200	10₫	8
1	2500 2000	300-1000	300	325	325	12 ø	100	12 	200	12 	100	16₫	100	16₫	100	12¢	100	10 ø	200	10₫	200	10 ø	200	10₫	8

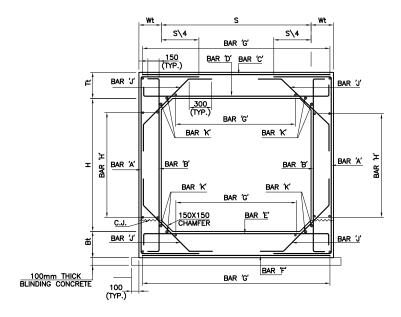



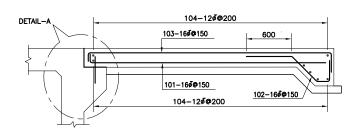



TYP. REINFORCEMENT DETAIL OF APPROACH SLAB

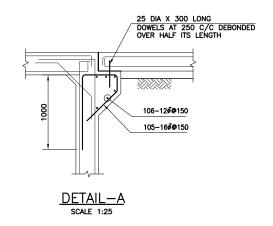



NOTES:-


- 1- BAR CUT LENGTH SHALL BE IN ACCORDANCE WITH LENGTH OF CULVERT.
 2- ALL STURCTURAL CONCRETE SHALL BE CLASS 'A3' CONCRETE.
- 3- ALL STURCTURAL REINFORCEMENT SHALL BE GRADE 60 STEEL.
 4- MINIMUM COVER TO THE REINFORCEMENT SHALL BE 50mm.
- 5- OVERLAP LENGTH OF REBAR SHALL BE 48 x DIA OF BARS.
- 6- FOR CULVERTS WITH SPAN LESS THAN ANY OF THOSE SHOWN IN TABLE, USE REINFORCEMENT AND SPACING FOR NEXT GREATER SIZE SPAN.MARK NECESSARY CHANGES IN BAR LENGTH AND QUANTITIES.
- 7- EXPANSION JOINTS SHALL BE PROVIDED AT MAX.15m LENGTH IF NECESSARY.
- 8- ELASTIC ASPHALT BOARD WITH 10mm. THICKNESS AT THE JOINT OF CONCRETE SHALL BE PROVIDED.
- 9- DO NOT LAP BAR C & F AT SUPPORT OR WALLS & DO NOT LAP BAR D & E AT MID SPAN
- 10- C.J MEANS CONSTRUCTION JOINT
- 11- MAXIMUM DESIGN BEARING PRESSURE IS 200 Kpg. WHICH SHELL BE VARIFIED AT SITE BEFORE EXECUTION.

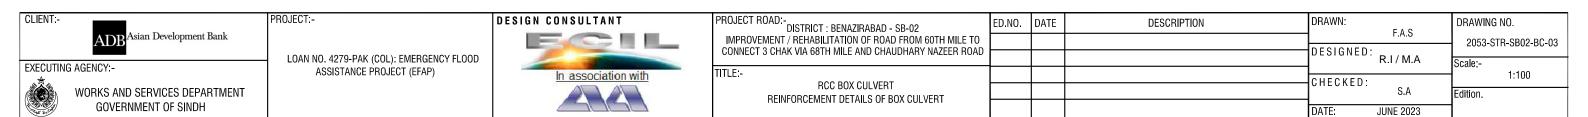


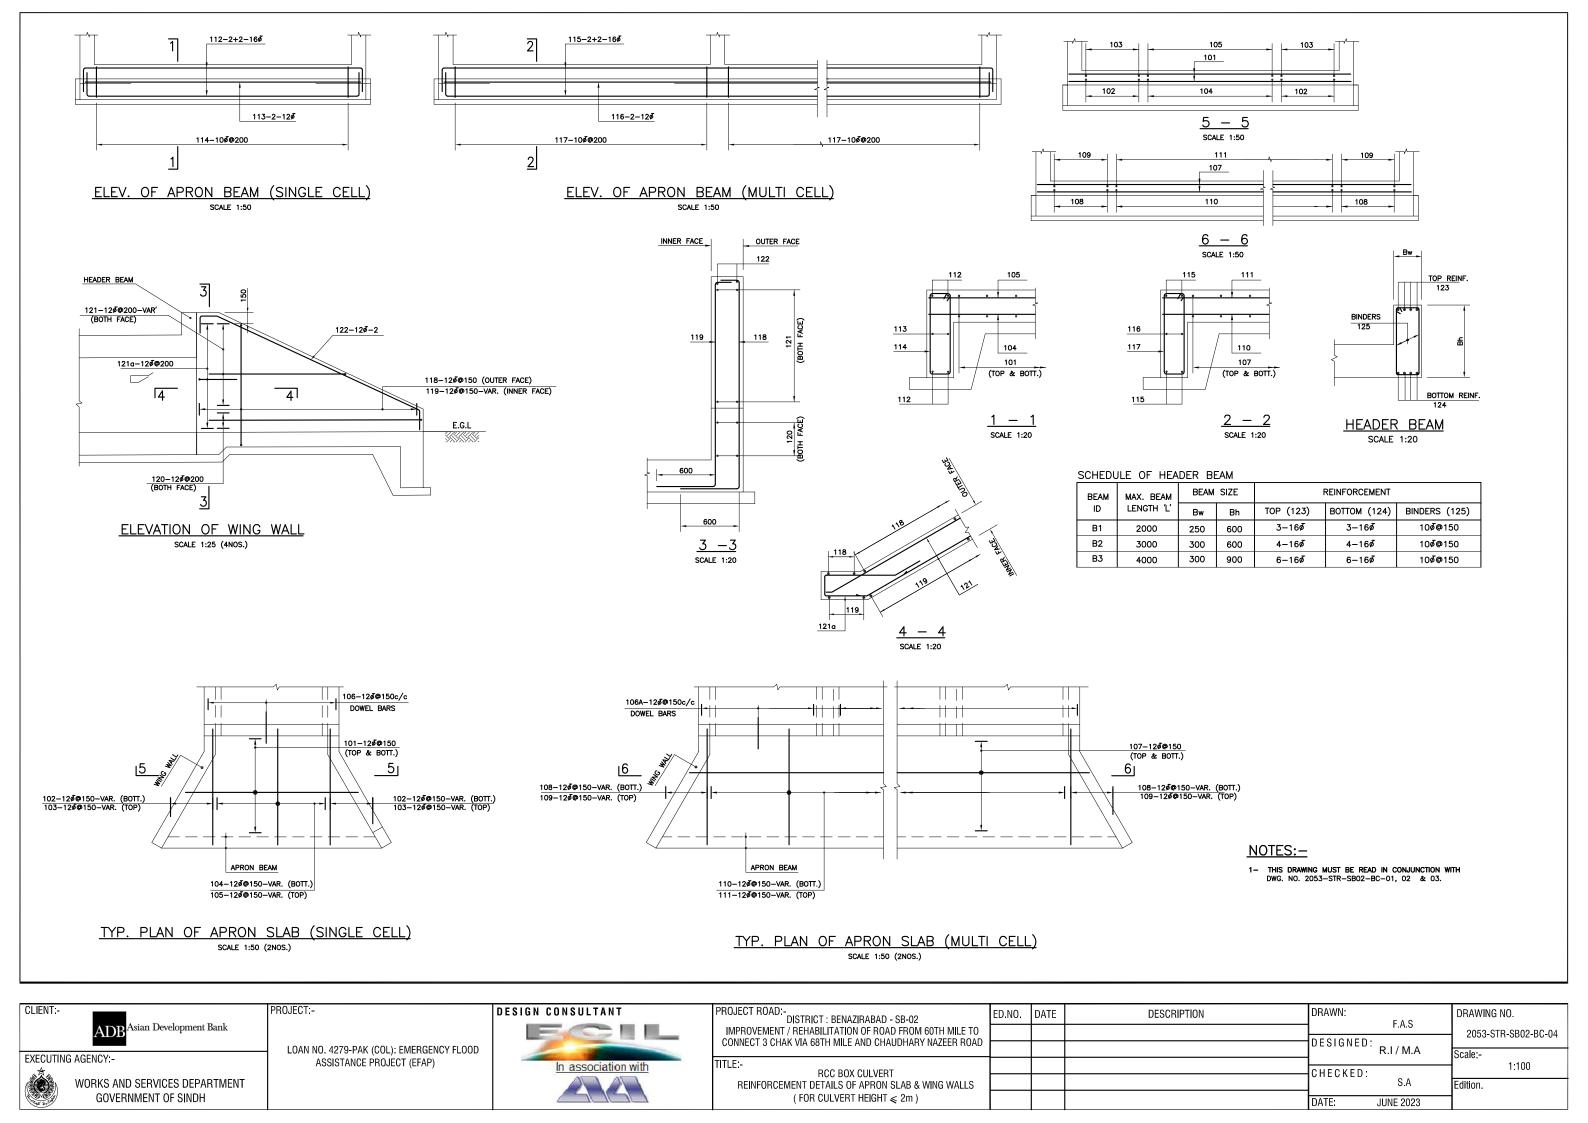


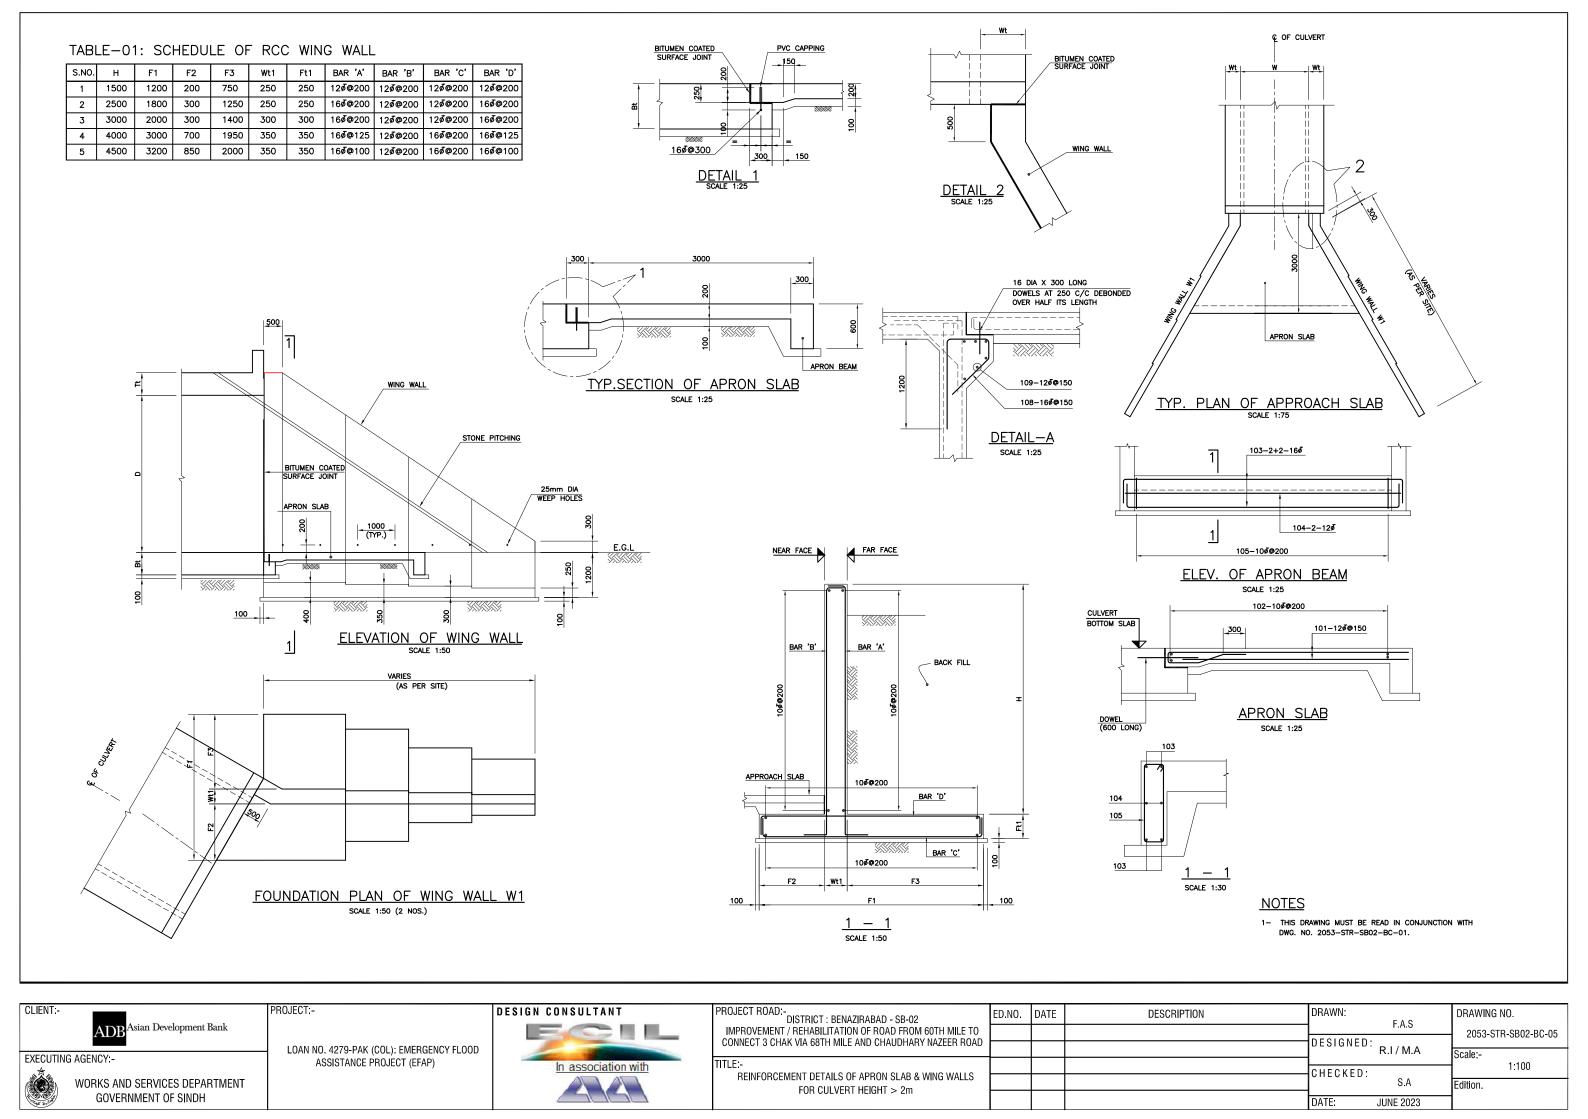


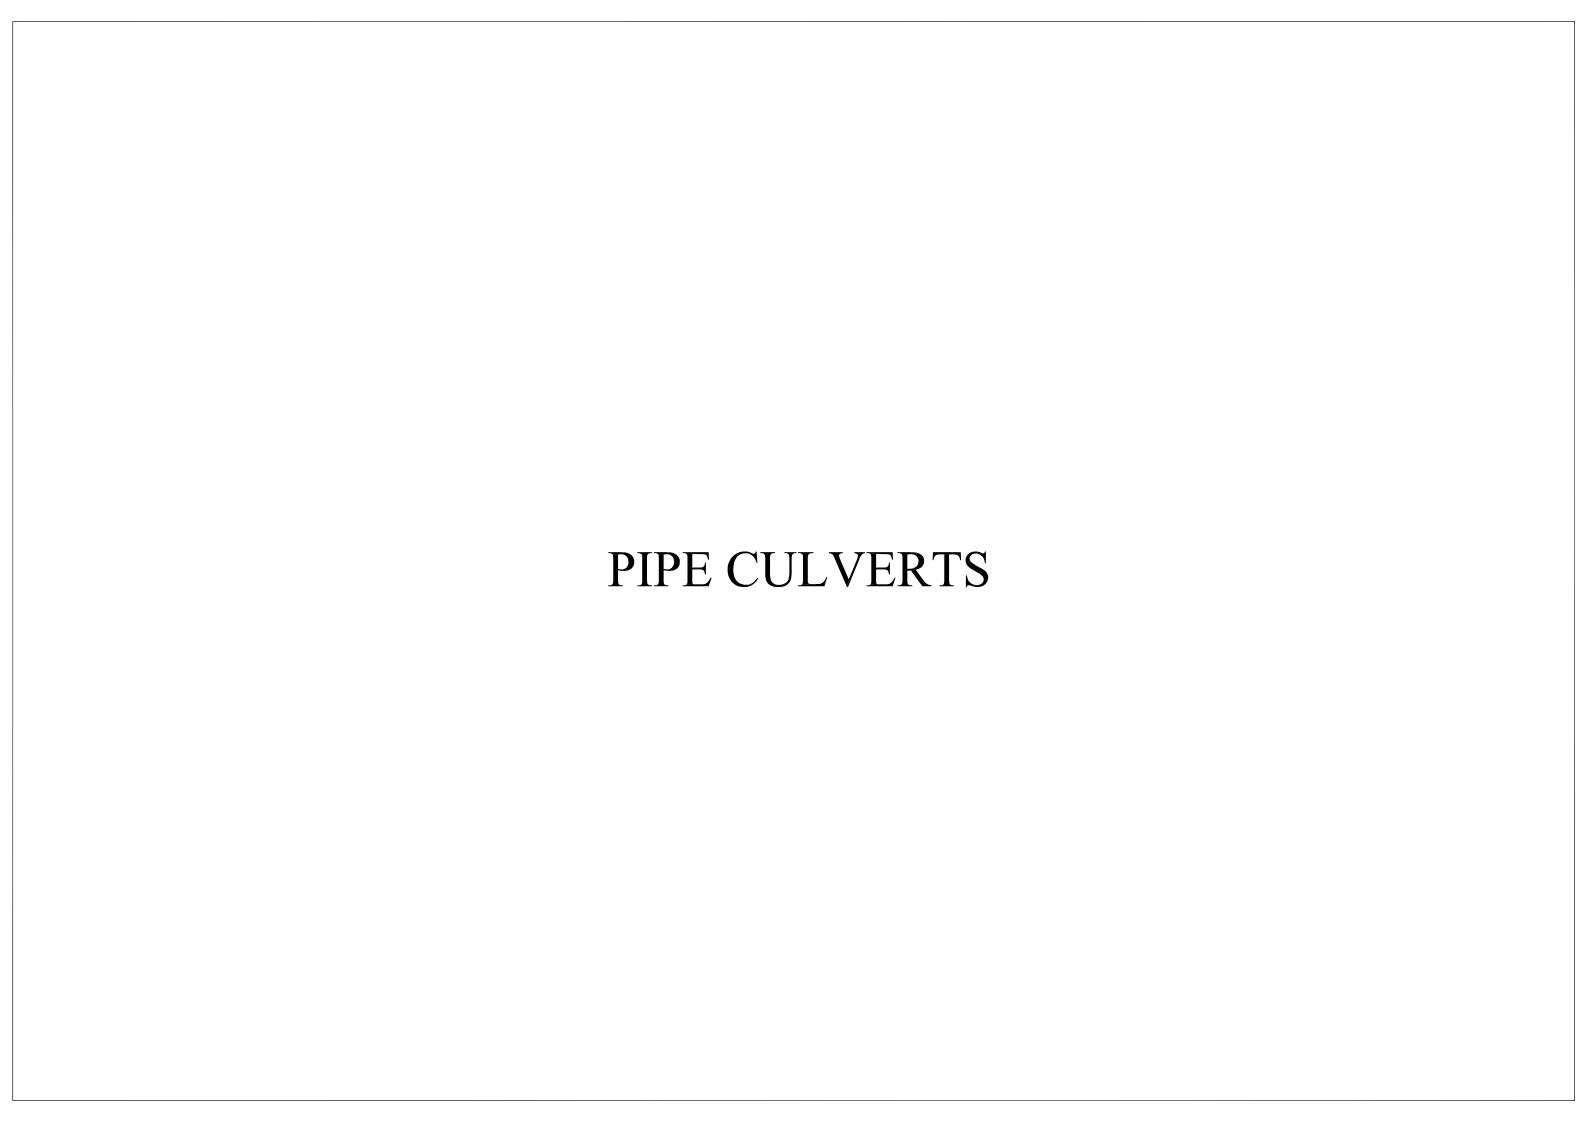

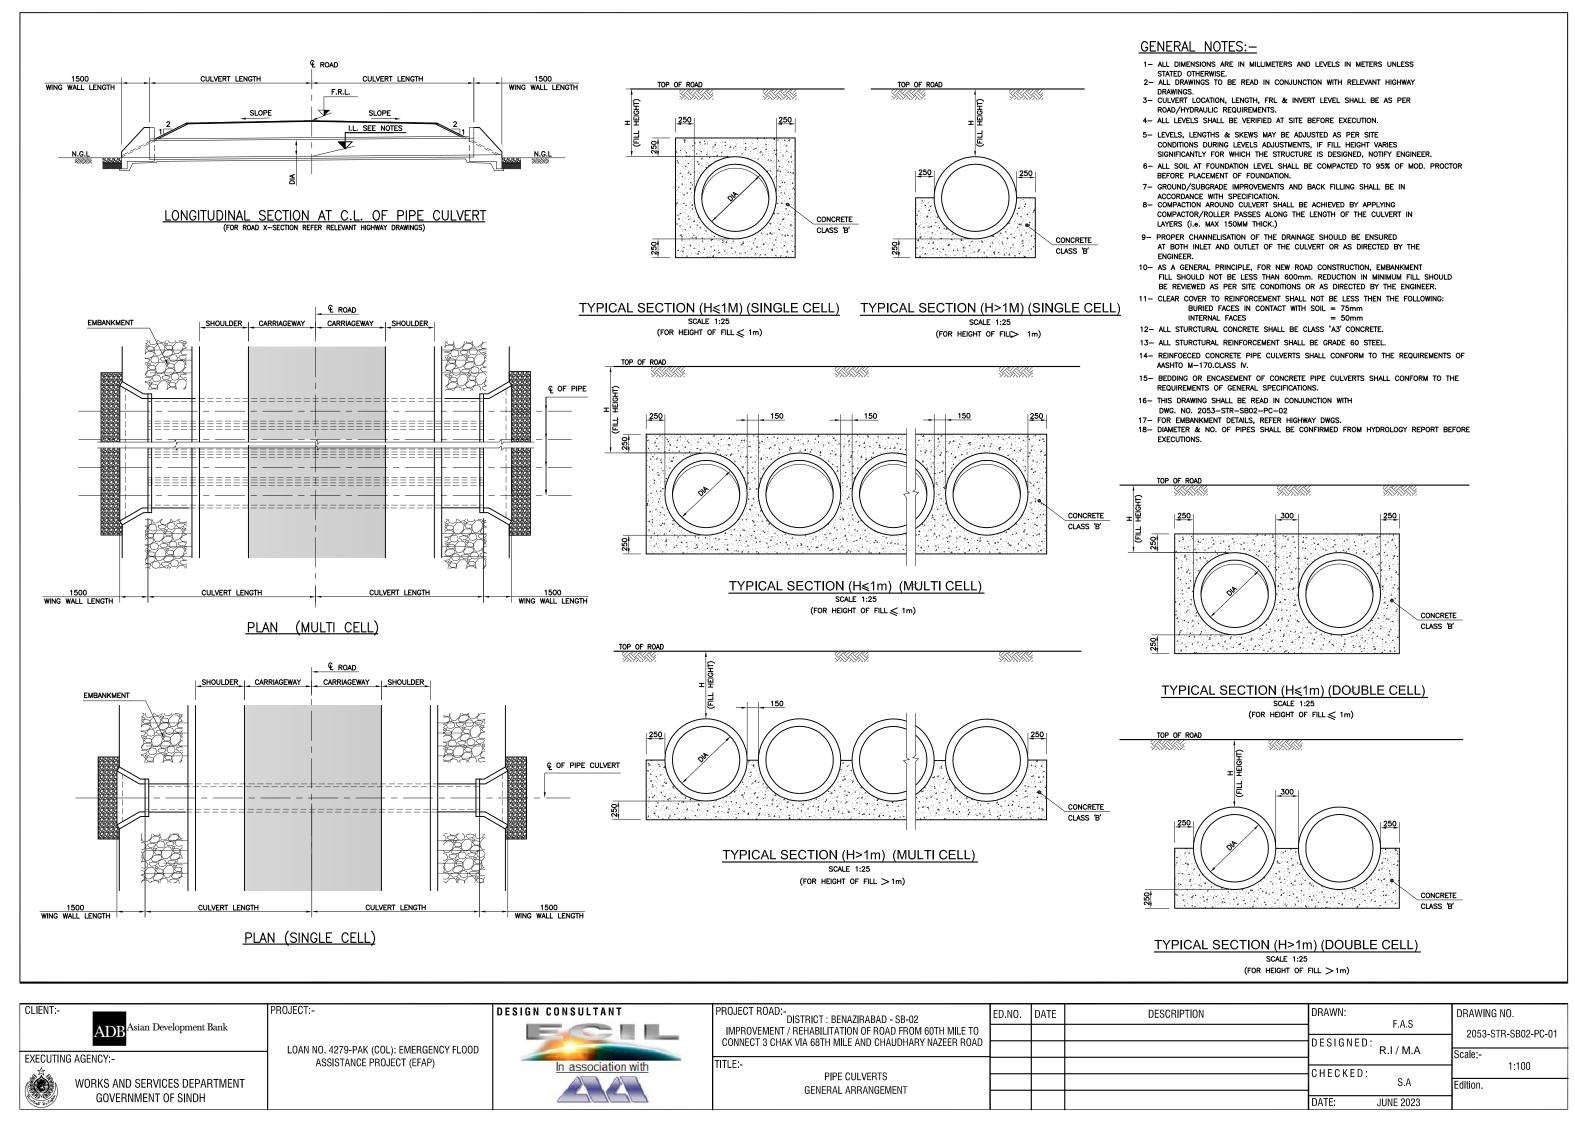

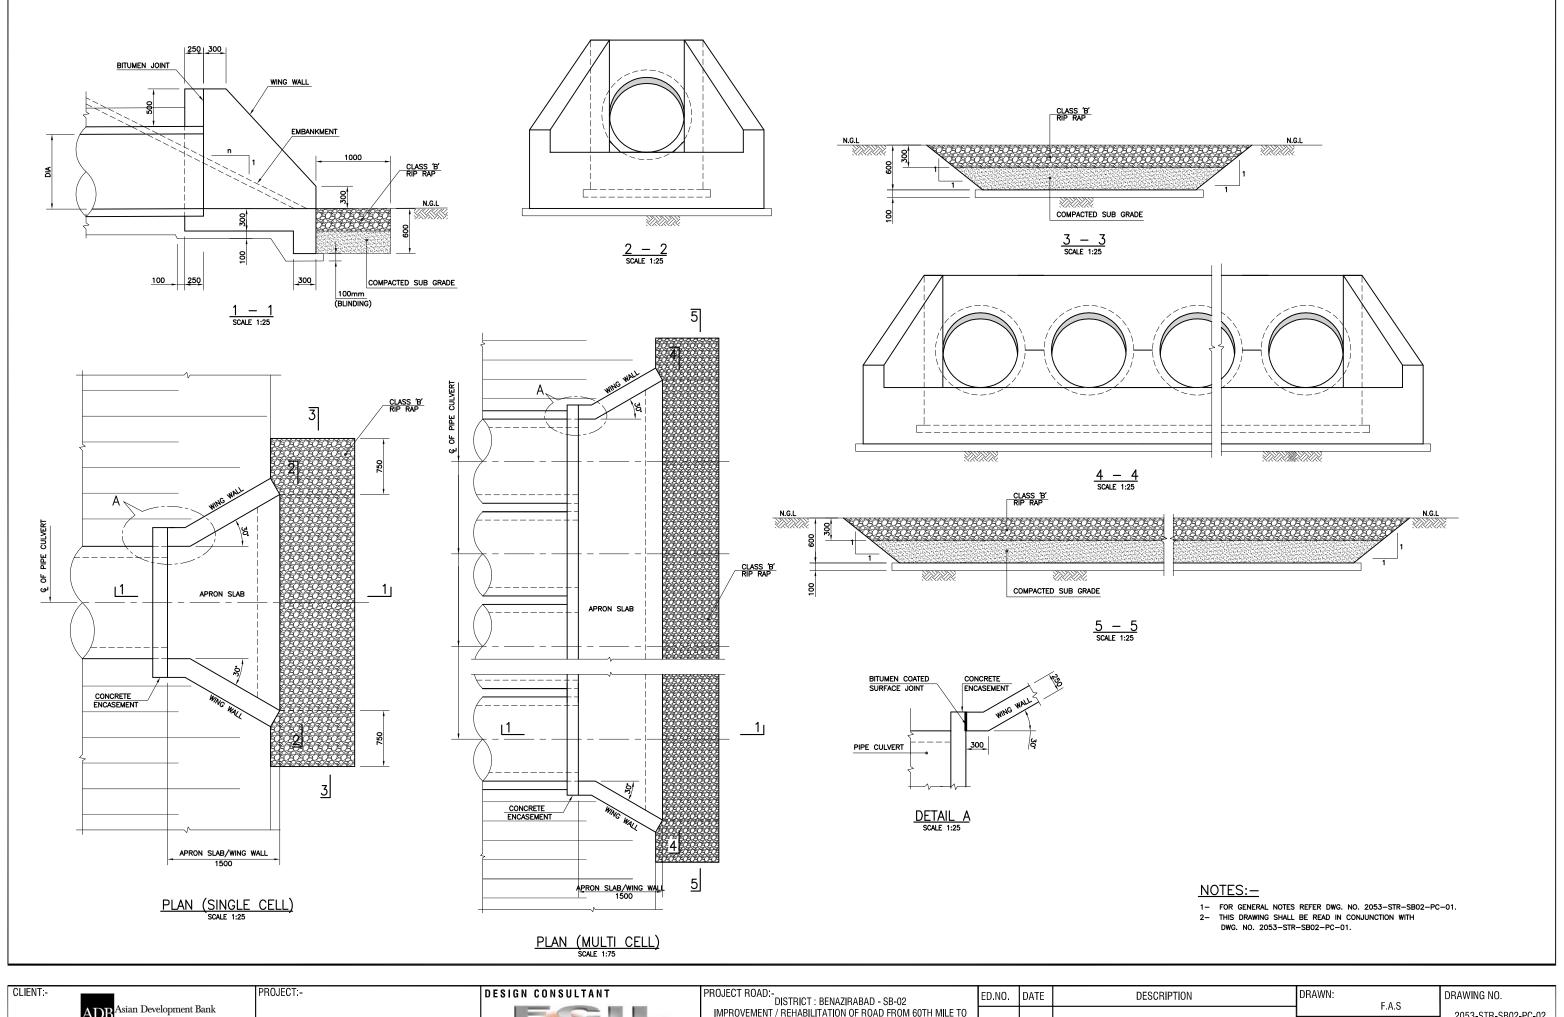

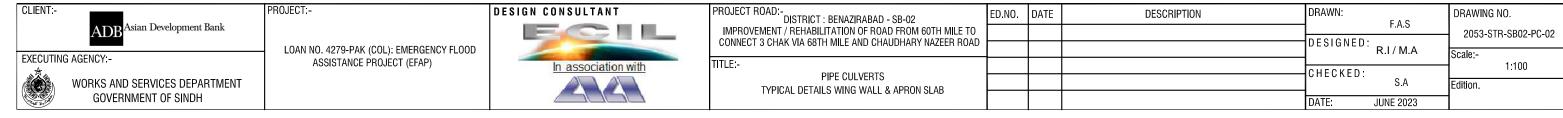

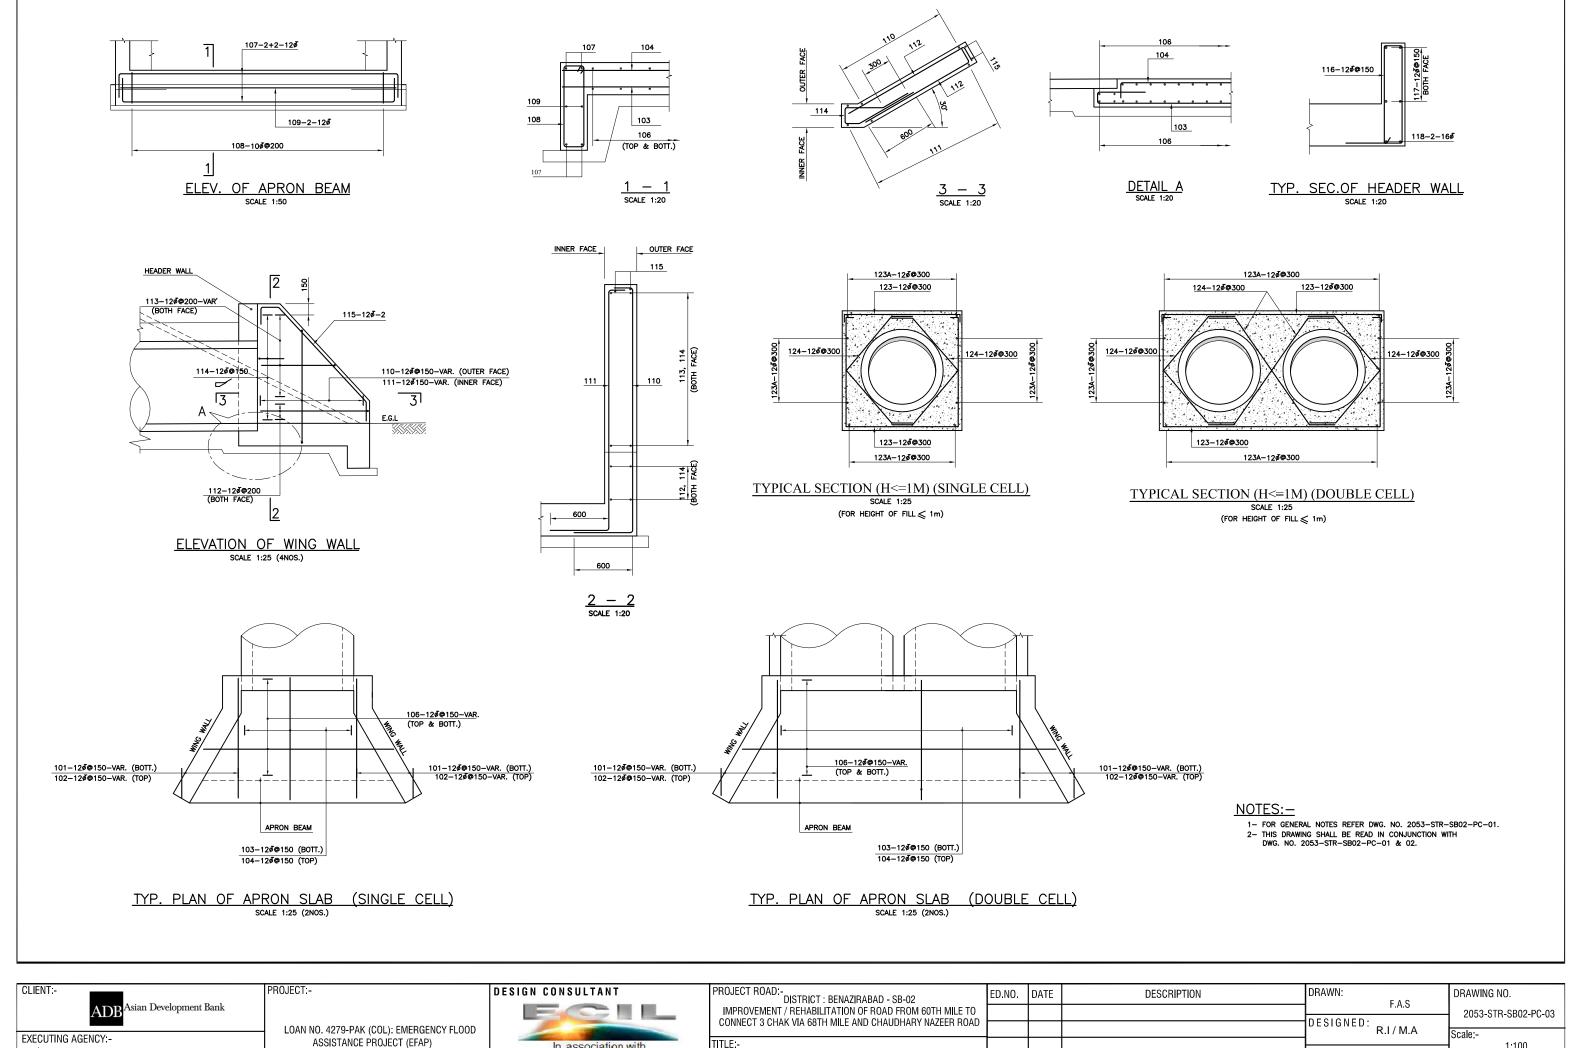

EXECUTING AGENCY:WORKS AND SERVICES DEPARTMENT GOVERNMENT OF SINDH

LOAN NO. 4279-PAK (COL): EMERGENCY FLOOD ASSISTANCE PROJECT (EFAP)

IMPROVEMENT / REHABILITATION OF ROAD FROM 60TH MILE TO CONNECT 3 CHAK VIA 68TH MILE AND CHAUDHARY NAZEER ROAD

TITLE:PIPE CULVERTS
REINFORCEMENT DETAILS

DATE: JUNE 2023

1.100

Edition.